

GENERAL NOTES

1.

THE CONTRACTOR SHALL PROVIDE ADEQUATE STAYS AND BRACING OF ALL FRAMING UNTIL ALL ELEMENTS OF DESIGN HAVE BEEN INCORPORATED IN THE PROJECT.
2.

CONTRACTOR SHALL FIELD VERIFY ALL DIMENSIONS PRIOR TO COMMENCING WITH NEW WORK.
3.

WORK UNDER THIS PERMIT DOES NOT REQUIRE SPECIAL INSPECTION OR STRUCTURAL OBSERVATION.
4.

IF APPLICABLE, FIRE WALLS/EAVES SHALL BE PROVIDED AND SHALL COMPLY WITH SECTION R302 AND THE FIRE-RATED DETAILS IN THESE PLANS BASED ON THE LOCATION OF THE ADU ON YOUR SITE.
5.

LOCATION OF HVAC SUBJECT TO FIELD INSPECTION.
6.

HERS VERIFICATION REQUIRED FOR THE HVAC COOLING, HVAC DISTRIBUTION, & HVAC FAN SYSTEMS. PROVIDE EVIDENCE OF THIRD PARTY VERIFICATION (HERS) TO PROJECT BUILDING INSPECTOR PRIOR TO FINAL INSPECTION.

SITE PLAN REQUIREMENTS

- APPLICANT SHALL PROVIDE A SITE PLAN FOR THE PROPERTY SHOWING THE LOCATION OF THE PROPOSED ADU AND INCORPORATE IT INTO THIS PLAN SET PRIOR TO SUBMITTING PLANS FOR REVIEW.

•

LOCATION OF THE ADU SHALL COMPLY WITH ALL SETBACK REQUIREMENTS OF CURRENT ZONING.

•

SHOW ALL DIMENSIONS FROM PROPERTY LINES AND EXISTING STRUCTURES TO THE PROPOSED ADU.

•

SHOW ALL EXISTING AND PROPOSED UTILITIES.

•

SITE PLAN SHALL BE DRAWN TO SCALE (INCLUDE NORTH ARROW)

FIRE APPARATUS ACCESS ROAD STANDARD

1.

BUILDINGS, PORTIONS OF BUILDINGS CONSTRUCTED OR MOVED AND LOCATED WITHIN 150 FEET OR MORE FROM THE PUBLIC ROADWAY SHALL CONFORM TO THE SAN JOAQUIN COUNTY FIRE CHIEF'S ASSOCIATION FIRE ROAD STANDARDS. THE EXISTING OR PROPOSED FIRE ACCESS ROAD/DRIVEWAY SHALL BE CLEARLY DELINEATED ON THE SITE-PLAN AND IN CONFORMANCE WITH THOSE STANDARDS AS TO DRIVEWAY WIDTH, ROAD SURFACE, HEIGHT CLEARANCE AND ROAD TURNAROUND DETAILS.

EXPANSIVE SOIL

2.

PROJECTS LOCATED IN AN EXPANSIVE SOIL AREA: FOOTINGS AND PIERS SHALL HAVE A MINIMUM EMBEDMENT DEPTH OF 18 INCHES FROM THE SOIL SURFACE AND HAVE (2) - #4 REBAR AT THE TOP AND (2) - #4 REBAR AT THE BOTTOM OF THE FOOTING. ( WWW.SJMAP.ORG/DISTRICT VIEWER/ )

SITE DRAINAGE

3.


LOTS SHALL BE GRADED TO DRAIN SURFACE AWAY FROM THE FOUNDATION WALLS AND THE GRADE SHALL FALL A MINIMUM OF 6" WITHIN THE FIRST 10'-0".

ADDRESS IDENTIFICATION

1.

BUILDINGS SHALL BE PROVIDED WITH APPROVED ADDRESS IDENTIFICATION. THE ADDRESS IDENTIFICATION SHALL BE LEGIBLE AND PLACED IN A POSITION THAT IS VISIBLE FROM THE STREET OR ROAD FRONTING THE PROPERTY. ADDRESS IDENTIFICATION CHARACTERS SHALL CONTRAST WITH THEIR BACKGROUND. ADDRESS NUMBERS SHALL BE ARABIC NUMBERS OR ALPHABETICAL LETTERS. NUMBERS SHALL NOT BE SPELLED OUT. EACH CHARACTER SHALL BE NOT LESS THAN 4 INCHES IN HEIGHT WITH A STROKE WIDTH OF NOT LESS THAN 0.5 INCH. WHERE REQUIRED BY THE FIRE CODE OFFICIAL, ADDRESS IDENTIFICATION SHALL BE PROVIDED IN ADDITIONAL APPROVED LOCATIONS TO FACILITATE EMERGENCY RESPONSE. WHERE ACCESS IS BY MEANS OF A PRIVATE ROAD AND THE BUILDING ADDRESS CANNOT BE VIEWED FROM THE PUBLIC WAY, A MONUMENT, POLE, OR OTHER SIGN OR MEANS SHALL BE USED TO IDENTIFY THE STRUCTURE. ADDRESS IDENTIFICATION SHALL BE MAINTAINED. CRC R319.1DF

PLACE SITE PLAN IN BOX

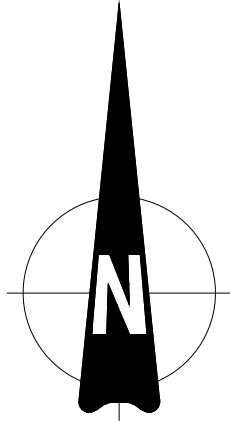

SCALE: 1" =

BMP LEGEND

PDS 659	BROW DITCH	
PDS 659	BERM	
DIRECTION OF LOT DRAINAGE		

MATERIALS & WASTE MANAGEMENT BMPs:

WM-1	MATERIAL DELIVERY & STORAGE
WM-4	SPILL PREVENTION AND CONTROL
WM-8	CONCRETE WASTE MANAGEMENT
WM-5	SOLID WASTE MANAGEMENT
WM-9	SANITARY WASTE MANAGEMENT
WM-6	HAZARDOUS WASTE MANAGEMENT

TEMPORARY RUNOFF CONTROL BMPs:

SS-2	PRESERVATION OF EXISTING VEGETATION	
SS-3	BONDED OR STABILIZED FIBER MATRIX (WINTER)	
SS-4	HYDROSEEDING (SUMMER)	
SS-6 / SS-8	STRAW OR WOOD MULCH	
SS-7	PHYSICAL STABILIZATION (WINTER)	
SS-10	ENERGY DISSIPATOR	
SC-1	SILT FENCE	
SC-2	SEDIMENT / DESILTING BASIN	
SC-5	FIBER ROLLS	
SC-6 / SC-8	GRAVEL OR SAND BAGS	
SC-7	STREET SWEEPING AND VACUUMING	
SC-10	STORM DRAIN INLET PROTECTION	
NS-2	DEWATERING FILTRATION	
TC-1	STABILIZED CONSTRUCTION ENTRANCE	
TC-2	CONSTRUCTION ROAD STABILIZATION	
TC-3	ENTRANCE / EXIT TIRE WASH	

POST-CONSTRUCTION SITE DESIGN BMPs

4.3.1	MAINTAIN NATURAL DRAINAGE PATHWAYS AND HYDROLOGIC FEATURES
4.3.2	CONSERVE NATURAL AREAS, SOILS, AND VEGETATION
4.3.3	MINIMIZE IMPERVIOUS AREA
4.3.4	MINIMIZE SOIL COMPACTION
4.3.5	IMPERVIOUS AREA DISPERSION
4.3.6	RUNOFF COLLECTION
4.3.7	LANDSCAPING WITH NATIVE OR DROUGHT TOLERANT SPECIES
4.3.8	HARVESTING AND USING PRECIPITATION

POST CONSTRUCTION SOURCE CONTROL BMPs

4.2.1	PREVENTION OF ILLICIT DISCHARGES INTO THE MS4
4.2.2	STORM DRAIN STENCILING AND POSTING OF SIGNAGE
4.2.3	PROTECTED OUTDOOR MATERIALS STORAGE AREAS
4.2.4	PROTECT MATERIALS STORED IN OUTDOOR WORK AREAS
4.2.5	PROTECT TRASH STORAGE AREAS
4.2.6	ADDNL BMPs BASED ON POTENTIAL RUNOFF POLLUTANTS:

MODEL WATER EFFICIENT LANDSCAPE ORDINANCE

1.

ON APRIL 1, 2015, GOVERNOR BROWN ISSUED EXECUTIVE ORDER EO 8-28-15 DIRECTING THE DEPARTMENT OF WATER RESOURCES TO UPDATE A PREVIOUS MODEL WATER EFFICIENT LANDSCAPE ORDINANCE (MWEL) MTO BE MORE STRINGENT AND REDUCE LANDSCAPE WATER USE.
2.

ALL NEW PROJECTS, WHETHER THEY INCLUDE LANDSCAPING OR NOT, REQUIRE SUBMITTAL OF A COMPLETED MWEL PROJECT INFORMATION FORM. THE PLAN REVIEW PROCESS WILL NOT BE COMPLETED WITHOUT A SIGNED MWEL FORM UPLOADED TO ACEELA DURING PLAN REVIEW.

ALTERNATIVE ROOF FRAMING SYSTEM

1.

AN ALTERNATIVE TO A CONVENTIONAL CUT-AND-STACK ROOF FRAMING SYSTEM (RAFTERS/CEILING JOISTS) IS A PREFABRICATED ROOF TRUSS FRAMING SYSTEM. MANUFACTURED ROOF TRUSS CALCULATIONS SHALL BE SUBMITTED FOR REVIEW AS PART OF THE CONSTRUCTION DOCUMENTS.

RESTRICTIONS AND REQUIREMENTS FOR USE OF PLANS

1.

THESE PLANS MAY ONLY BE USED FOR CONSTRUCTION ON LOTS WITHIN THE COUNTY OF SAN JOAQUIN AND ONLY IF ALL PROPERTY OWNERS EXECUTE A HOLD HARMLESS AGREEMENT.

SHEET INDEX

SHEET #	SHEET NAME
A0.1	COVER SHEET / SITE PLAN
A0.2	GENERAL NOTES / CAL-GREEN NOTES
A1	FLOOR PLN
A2	ELECTRICAL PLAN
A3	FOUNDATION PLAN
A4	BRACED WALL PLAN
A5	ROOF PLAN
A6	CEILING FRAMING PLAN AND DETAILS
A7	FRONT AND REAR ELEVATIONS
A8	RIGHT AND LEFT ELEVATIONS
A9	DETAILS
T-24	ENERGY COMPLIANCE REPORT - T-24
FS	FIRE SPRINKLER PLANS ( * )
PV	PV SOLAR SYSTEM PLANS ( ** )

NOTE: (\*) INDICATES: IF FIRE SPRINKLER SYSTEM REQUIRED ;  
(\*\*) INDICATES: IF PV SOLAR SYSTEM REQUIRED

NO PV REQUIRED: PER SECTION 150.1(C)(14), EXCEPTION 2 (IF ENERGY COMPLIANCE REPORT SIZED PV SYSTEM < 1.8KWDC)

ADU OPTIONS

PRE-MANUFACTURED TRUSSES  
WOOD OR FIBER-CEMENT SIDING

GENERAL CODES

THIS PROJECT SHALL COMPLY WITH THE FOLLOWING BUILDING CODES AND ASSOCIATED SAN JOAQUIN COUNTY AMENDMENTS:  
-2022 CALIFORNIA BUILDING CODE (CBC)  
-2022 CALIFORNIA RESIDENTIAL CODE (CRC)  
-2022 CALIFORNIA PLUMBING CODE (CPC)  
-2022 CALIFORNIA MECHANICAL CODE (CMC)  
-2022 CALIFORNIA ELECTRICAL CODE (CEC)  
-2022 CALIFORNIA BUILDING ENERGY EFFICIENCY STANDARDS  
-2022 CALIFORNIA GREEN BUILDING STANDARDS CODE (CGBSC)  
-2022 CALIFORNIA FIRE CODE (CFC)

DESIGN BASIS

CONVENTIONAL LIGHT FRAME CONSTRUCTION: TYPE-VB  
OCCUPANCY: R-3  
CLIMATE ZONE: 12  
ROOF LIVE LOAD: 20 PSF  
ULTIMATE WIND SPEED: 110 MPH  
EXPOSURE CATEGORY: C  
SOIL SITE CLASS: D  
RISK CATEGORY: II  
S<sub>DES</sub>: 1.25  
SEISMIC DESIGN CATEGORY: D<sub>s</sub>, D<sub>o</sub>, D<sub>1</sub>  
ALLOW SOIL VERTICAL BEARING PRESSURE: 1500 PSF (SEE EXPANSIVE SOIL NOTE)  
ALLOW SOIL LATERAL BEARING PRESSURE: 100 PSF/FT

ENERGY EFFICIENCY SPECIAL FEATURES

SPECIFY AS INDICATED IN CF1R FORM (TITLE 24):

- 
- 

ENERGY EFFICIENCY HERS VERIFICATION

SPECIFY AS INDICATED IN CF1R FORM (TITLE 24):

- DUCT SEALING ( Y or N )
- REFRIGERANT CHARGE ( Y or N )
- COOLING SYSTEM AIRFLOW ( Y or N )
- COOLING SYSTEM UNIT FAN EFFICACY ( Y or N )
- COOLING SYSTEM SEER AND/OR EER ABOVE MIN. ( Y or N )
- WHOLE-BUILDING VENTILATION AIRFLOW ( Y or N )
- BUILDING ENVELOPE AIR LEAKAGE ( Y or N )
- QUALITY INSULATION INSTALLATION ( Y or N )
- OTHER (SPECIFY BELOW)

PROPERLY COMPLETED AND SIGNED CERTIFICATES OF INSTALLATION (CF2R FORMS) SHALL BE PROVIDED TO THE INSPECTOR IN THE FIELD. FOR PROJECTS REQUIRING HERS VERIFICATION, THE CF2R FORMS SHALL BE REGISTERED WITH A CALIFORNIA-APPROVED HERS PROVIDER DATA REGISTRY.

PROPERLY COMPLETED CERTIFICATES OF VERIFICATION (CF3R FORMS) SHALL BE PROVIDED TO THE INSPECTOR IN THE FIELD FOR ITEMS REQUIRING HERS VERIFICATION. CF3R FORMS SHALL BE REGISTERED WITH A CALIFORNIA-APPROVED HERS PROVIDER DATA REGISTRY.

VICINITY MAP	OWNER INFORMATION	DESIGNER INFORMATION	PARCEL INFORMATION	PROJECT SCOPE	PERVIOUS AREA INFORMATION	IMPERVIOUS AREA INFORMATION																																																																																																
	<table><tr><td>NAME</td><td>-</td></tr><tr><td>ADDRESS</td><td>-</td></tr><tr><td>PHONE</td><td>-</td></tr><tr><td>EMAIL</td><td>-</td></tr></table>	NAME	-	ADDRESS	-	PHONE	-	EMAIL	-	<table><tr><td>NAME</td><td>-</td></tr><tr><td>ADDRESS</td><td>-</td></tr><tr><td>PHONE</td><td>-</td></tr><tr><td>EMAIL</td><td>-</td></tr></table>	NAME	-	ADDRESS	-	PHONE	-	EMAIL	-	<p>APN:</p> <p>SITE ADDRESS</p> <p>PRIMARY SFR EQUIPPED WITH AN AUTOMATIC FIRE SPRINKLER SYSTEM PER NFPA 13D? (Y OR N)</p> <p>PROPERTY CONNECTED TO THE ELECTRICAL GRID? (Y OR N)</p> <p>PROPERTY SERVICED BY PROPANE? (Y OR N) (PLANS <b>NOT</b> USABLE FOR PROPANE SERVICE)</p> <p>PROPERTY SERVICED BY NATURAL GAS? (Y OR N) (PLANS <b>NOT</b> USABLE FOR GAS SERVICE)</p> <p><b>FHA</b> - SITE IS IN A FLOOD HAZARD AREA? (Y OR N) (PLANS <b>NOT</b> USABLE FOR FLOOD HAZARD AREA)</p> <p><b>WUI</b> - SITE IS IN A FIRE HAZARD AREA? (Y OR N) (PLANS <b>NOT</b> USABLE FOR FIRE HAZARD ZONE)</p>	<p>PROPOSED <b>746</b> SF DETACHED ACCESSORY DWELLING UNIT</p> <p>EXISTING SFR CONDITIONED FLOOR AREA: _____</p> <table><tr><th colspan="2">GRADING</th></tr><tr><td>CUT</td><td>CU YDS</td></tr><tr><td>CUT</td><td>-</td></tr><tr><td>FILL</td><td>-</td></tr><tr><td>TOTAL</td><td>-</td></tr></table>	GRADING		CUT	CU YDS	CUT	-	FILL	-	TOTAL	-	<table><tr><th colspan="5">PERVIOUS SURFACE AREA DETAIL</th></tr><tr><th>SITE ID</th><th>PERVIOUS ITEM</th><th>DIMENSIONS</th><th>AREA sf)</th><th>NOTES</th></tr><tr><td>1</td><td>NA</td><td>NA</td><td>NA</td><td>NA</td></tr><tr><td>2</td><td>NA</td><td>PER PLAN</td><td>NA</td><td>NA</td></tr><tr><td>3</td><td>NA</td><td>NA</td><td>NA</td><td>NA</td></tr><tr><td>4</td><td>NA</td><td>NA</td><td>NA</td><td>NA</td></tr><tr><td>5</td><td>NA</td><td>NA</td><td>NA</td><td>NA</td></tr></table> <p>PERVIOUS ELEMENT MANUFACTURER: _____</p> <p>PERVIOUS ELEMENT SLOPE AND DIRECTION OF SLOPE: _____</p> <p>MAINTENANCE PROGRAM: _____</p> <p>PERVIOUS ELEMENT CROSS SECTION LOCATED IN SHEET: _____</p> <p>CONSTRUCTED PERVIOUS SURFACES SHALL NOT BE SEALED</p>	PERVIOUS SURFACE AREA DETAIL					SITE ID	PERVIOUS ITEM	DIMENSIONS	AREA sf)	NOTES	1	NA	NA	NA	NA	2	NA	PER PLAN	NA	NA	3	NA	NA	NA	NA	4	NA	NA	NA	NA	5	NA	NA	NA	NA	<table><tr><th colspan="5">IMPERVIOUS SURFACE AREA DETAIL</th></tr><tr><th>SITE ID</th><th>IMPERVIOUS ITEM</th><th>DIMENSIONS</th><th>NEW OR REPLACED AREA (sf)</th><th>EXISTING AREA (sf)</th></tr><tr><td>1</td><td>ADU + OVERHANGS</td><td>PER PLAN</td><td>NA</td><td>NA</td></tr><tr><td>2</td><td>SFD</td><td>PER PLAN</td><td>NA</td><td>NA</td></tr><tr><td>3</td><td>DRIVEWAY</td><td>-</td><td>NA</td><td>NA</td></tr><tr><td>4</td><td>NA</td><td>NA</td><td>NA</td><td>NA</td></tr><tr><td>5</td><td>NA</td><td>NA</td><td>NA</td><td>NA</td></tr></table>	IMPERVIOUS SURFACE AREA DETAIL					SITE ID	IMPERVIOUS ITEM	DIMENSIONS	NEW OR REPLACED AREA (sf)	EXISTING AREA (sf)	1	ADU + OVERHANGS	PER PLAN	NA	NA	2	SFD	PER PLAN	NA	NA	3	DRIVEWAY	-	NA	NA	4	NA	NA	NA	NA	5	NA	NA	NA	NA
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By using these standard plans, the user agrees to release San Joaquin County from any and all claims, liabilities, suits, and demands on account of any injury, damage, or loss to persons or property, including injury or death, or economic losses, arising out of the use of these construction documents. The use of these plans does not eliminate or reduce the user's responsibility to verify any and all information.

COVER SHEET/SITE PLAN  
SAN JOAQUIN COUNTY, PLANNING & DEVELOPMENT SERVICES  
746 SF ACCESSORY DWELLING 2-BEDROOM UNIT  
BUILDING DIVISION  
DATE REVISED: DEC 2022



COS  
VERSION: 3.0  
Sheet Number

A0.1



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**SAN JOAQUIN COUNTY**  
**746 SF ACCESSORY DWELLING 2-BEDROOM UNIT**  
**BUILDING DIVISION**  
DATE REVISED: MAY, 2025



COS  
VERSION: 3.0

Sheet Number

A0.2

## CA MECHANICAL CODE NOTES

- EXHAUST SYSTEMS
- EXHAUST DUCTS SHALL TERMINATE OUTSIDE THE BUILDING AND BE EQUIPPED WITH BACK DRAFT DAMPERS. (CMC SECTION 504.1)
  - KITCHEN RANGE VENTILATION DUCTS SHALL BE METAL WITH SMOOTH INTERIOR SURFACES.(CMC SECTION 504.3)
  - THE CLOTHES DRYER SHALL BE EXHAUSTED USING APPROVED 4" Ø MIN DUCTING. THE DUCTING SHALL NOT EXCEED 14' WITH A MAXIMUM OF 2-90° ELBOWS, UNLESS PERMITTED BY MANUFACTURER INSTRUCTIONS AND THE LOCAL JURISDICTION. (CMC SECTION 504.4)
  - NO HVAC OR WATER HEATER VENTS SHALL TERMINATE LESS THAN 4'-0" BELOW OR TO THE SIDE, OR LESS THAN 1'-0" ABOVE ANY DOOR OR OPERABLE WINDOW. (CMC SECTION 806.6)
- VENTILATION (PER CMC SECTION 402, CAEC SECTION 150(H), & ASHRAE 62.2)
- KITCHEN - 100 CFM (ON DEMAND), 1 SONE, 5" Ø MIN DUCT
  - BATHROOM - 50 CFM (ON DEMAND), 1 SONE, 4" Ø MIN DUCT
    - WHOLE HOUSE FAN - PER PLANS (PER ENERGY COMPLIANCE REPORT)
    - INDOOR AIR QUALITY FAN - PER PLANS (PER ENERGY COMPLIANCE REPORT)
- APPLIANCES
7. APPLIANCES INSTALLED IN ATTICS SHALL BE ACCESSIBLE THROUGH AN OPENING AND PASSAGEWAY AT LEAST AS LARGE AS THE LARGEST COMPONENT OF THE APPLIANCE AND NOT LESS THAN 22" X 30" WITH MINIMUM 30" HEADROOM CLEARANCE. THE APPLIANCE SHALL BE LOCATED WITHIN 20" OF THE PASSAGEWAY ACCESS WHEN ATTIC HAS LESS THAN 6" HEADROOM. PASSAGEWAY SHALL BE UNOBSTRUCTED AND SHALL HAVE SOLID FLOORING NOT LESS THAN 24" WIDE FROM THE ENTRANCE TO THE APPLIANCE. A PERMANENT 120- VOLT RECEPTACLE OUTLET AND LIGHTING FIXTURE SHALL BE LOCATED AT THE ENTRANCE TO THE PASSAGEWAY. (CMC 304.4, CPC 509.4).

## CA RESIDENTIAL CODE NOTES

- WINDOWS
- ALL NEW OR REPLACED WINDOWS SHALL BE DUAL GLAZED WITH LOW-E GLASS. DO NOT REMOVE NFRC STICKERS FROM GLAZING PRIOR TO APPROVED INSPECTION. BEDROOM WINDOWS SHALL HAVE A MINIMUM NET CLEAR ESCAPE OPENING OF 5.7 SF WITH A MINIMUM NET CLEAR OPENING HEIGHT OF 24" AND MINIMUM NET CLEAR OPENING WIDTH OF 20". THE WINDOW OPENING BOTTOM EDGE SHALL NOT BE MORE THAN 44" ABOVE THE FLOOR. (CRC SECTION R310)
  - THE CONTRACTOR SHALL PROVIDE SAFETY GLAZING FOR ALL CONDITIONS DEEMED A "HAZARDOUS LOCATION" PER CRC SECTION R308.4.
- BATHROOMS
- WALL FINISHES AT SHOWER/ BATHTUB ENCLOSURES SHALL CONSIST OF A NON- ABSORBENT SURFACE AND EXTEND UP TO SIX FEET ABOVE FINISH FLOOR PER CRC R307.2. "GREEN BOARD" IS NOT ACCEPTABLE IN SHOWER/ BATHTUB ENCLOSURES. ACCEPTABLE TILE BASED MATERIALS AT SHOWER/ BATHTUB ENCLOSURES INCLUDE FIBER CEMENT, FIBER MAT REINFORCED CONCRETE, GLASS MAT GYPSUM BACKERS, OR FIBER REINFORCED GYPSUM BACKERS. (CRC SECTION R702.4.2)

## CA ENERGY CODE NOTES

- MANDATOMRY REQUIREMENTMS - ALL NEW CONSTRUCTION
- MANDATORY MEASURES OF SECTION 150 SHALL APPLY ONLY TO AND/OR WITHIN THE SPECIFIC AREA OF THE ADDITION OR ALTERATION. (ENERGY CODE SECTION 150.2)MANDATORY MEASURES (ENERGY CODE SECTIONS 110 & 150)
  - MANDATORY REQUIREMENTS TO LIMIT AIR LEAKAGE (ENERGY CODE SECTION 110.7) - ALL JOIST PENETRATIONS, AND OTHER OPENINGS IN THE BUILDING ENVELOPE THAT ARE POTENTIAL SOURCE FOR AIR LEAKAGE SHALL BE CAULKED, GASKETED, WEATHER-STRIPPED OR OTHERWISE SEALED TO LIMIT INFILTRATION & EXFILTRATION.
  - PHOTOVOLTAIC REQUIREMENTS ALL LOW-RISE RESIDENTIAL BUILDINGS SHALL HAVE A PHOTOVOLTAIC (PV) SYSTEM MEETING THE MINIMUM REQUIREMENTS AS SPECIFIED IN JOINT APPENDIX J A1.1 WITH ANNUAL ELECTRICAL OUTPUT EQUAL TO OR GREATER THAN THE DWELLING'S ANNUAL ELECTRICAL USAGE AS DETERMINED BY EQUATION 150.1-C
  - PIPE INSULATION - (ENERGY CODE SECTION 150 (J)) HOT WATER PIPE INSULATION SHALL HAVE A MINIMUM WALL THICKNESS OF NOT LESS THAN THE DIAMETER OF THE PIPE FOR A PIPE UP TO 2" DIAMETER. INSULATE ALL PIPES USED TO CIRCULATE HOT WATER TO KITCHEN FIXTURES, TO A STORAGE TANK OR BETWEEN STORAGE TANKS. INSULATE THE FIRST 5' OF PIPING FROM THE WATER HEATER.
  - LIGHTING - (ENERGY CODE SECTION 150 (K))
    - EFFICACY - ALL INSTALLED LUMINARIES SHALL BE HIGH-EFFICACY IN ACCORDANCE W/ TABLE 150.0-A
    - RECESSED DOWN LIGHT LUMINARIES IN CEILINGS - ALL ASSEMBLIES SHALL BE IC RATED, AT RATED, SEALED, AND COMPLY W/ JOINT APPENDIX J A8. RECESSED ASSEMBLIES SHALL NOT CONTAIN SCREW BASE SOCKETS.
    - INTERIOR LIGHTING, SWITCHING DEVICES & CONTROLS - DIMMERS OR VACANCY SENSORS SHALL CONTROL ALL LUMINARIES REQUIRED TO HAVE A LIGHT SOURCE COMPLIANT W/ JOINT APPENDIX J A8. (CLOSETS LESS THAN 70SF & HALLWAYS DO NOT REQUIRE DIMMERS OR VACANCY SENSORS). AT LEAST ONE LUMINAIRE IN A BATHROOMS, GARAGES, LAUNDRY ROOMS, AND UTILITY ROOMS SHALL BE CONTROLLED BY AN OCCUPANT OR VACANCY SENSOR.
    - RESIDENTIAL OUTDOOR LIGHTING - ALL FIXTURES SHALL BE CONTROLLED BY EITHER PHOTOCELL & MOTION SENSOR, PHOTO CONTROL & AUTOMATIC TIME SWITCH, ASTRONOMICAL TIME CLOCK, OR EMCS.
  - HVAC - SEE TITLE 24 ENERGY CALCULATION DOCUMENTATION
  - WATER HEATER - (ENERGY CODE SECTION 150 (N)) WATER HEATER ASSEMBLIES SHALL BE "ON-DEMAND" COMPATIBLE.
    - LOCATE A GFI WITHIN 3' OF THE WATER HEATER, WITHOUT OBSTRUCTIONS. INSTANTANEOUS WATER HEATERS WITH AN INPUT RATING GREATER THAN 6.8 KBTU/HR SHALL HAVE ISOLATION VALVES ON BOTH THE COLD WATER SUPPLY AND THE HOT WATER PIPE LEAVING THE HOT WATER
    - SIZE THE GAS LINE FOR 200,000 BTU/H
    - PROVIDE A CONDENSATE DRAIN THAT IS NO MORE THAN 2" HIGHER THAN THE BASE OF THE INSTALLED WATER HEATER, AND ALLOWS FOR NATURAL DRAINING WITHOUT PUMP ASSISTANCE.
  - VENTILATION - (ENERGY CODE SECTION 150 (O)) ALL DWELLING UNITS SHALL MEET THE REQUIREMENTS OF ASHRAE 62.2 SEE CALIFORNIA MECHANICAL NOTES.
- PROJECT SPECIFIC REQUIREMENTS:**
- FOR COMPLIANCE WITH CA ENERGY CODE REQUIREMENTS, THESE PLANS ARE FOR AN ELECTRIC ONLY DWELLING. GAS SERVICE TO THE DWELLING IS NOT ALLOWED.**
- STANDARD MODEL:**
- WALL INSULATION = R-15 CAVITY
  - ATTIC/CEILING INSULATION: R-38 @ CEILING + R-13 UNDERSIDE OF ROOF DECK
  - WHOLE HOUSE FAN REQUIRED (PER ENERGY COMPLIANCE REPORT)
  - COOL ROOF RATED (CRRC) ROOFING MATERIAL REQUIRED
  - ROOFTOP SOLAR SYSTEM REQUIRED, 3.1 KW MIN. W/ MICRO INVERTERS (PER ENERGY COMPLIANCE REPORT)
  - WINDOWS: U-FACTOR = 0.3 MAX. / SHGC = 0.23 MAX.
  - WATER HEATER = 40 GALLON, HEAT PUMP
  - HVAC SYSTEM: ELECTRIC DUCTLESS MINI-SPLIT, HSPF = 10 MIN. / SEER = 15 MIN.


## CALGREEN CODE NOTES

- MANDATORY MEASURES (CALGREEN CH 4)
- | FIXTURE TYPE                    | MANDATORY FLOW RATE FOR NEW "WATER CONSERVING" FIXTURES |
|---------------------------------|---|
| SHOWERHEADS                     | 1.8 GPM @ 80 PSI  |
| LAVATORY FAUCETS                | 1.2 GPM @ 80 PSI  |
| KITCHEN FAUCETS                 | 1.2 GPM @ 80 PSI  |
| GRAVITY TANK TYPE WATER CLOSETS | 1.28 GAL/FLUSH  |
- WHEN SINGLE SHOWER FIXTURES ARE SERVED BY MORE THAN ONE SHOWER HEAD, THE COMBINED FLOW RATE OF ALL THE SHOWERHEADS SHALL NOT EXCEED THE MAXIMUM FLOW RATES SPECIFIED.
- ENHANCED DURABILITY AND REDUCED MAINTENANCE - (CAL GREEN 4.406)ANNUAL SPACES AROUND PIPES, ELECTRIC CABLES, CONDUITS OR OTHER OPENINGS INFLATES AT EXTERIOR WALLS, SHALL BE PROTECTED AGAINST THE PASSAGE OF RODENTS BY CLOSING SUCH OPENING WITH CEMENT MORTAR, CONCRETE MASONRY OR SIMILAR METHOD ACCEPTABLE TO THE BUILDING OFFICIAL.
  - POLLUTANT CONTROL - (CAL GREEN SECTION 4.504) AT THE TIME OF ROUGH INSTALLATION, DURING STORAGE ON THE CONSTRUCTION SITE AND UNTIL FINAL STARTUP OF THE HEATING, COOLING AND VENTILATING EQUIPMENT, ALL DUCT AND OTHER RELATED AIR DISTRIBUTION COMPONENT OPENINGS SHALL BE COVERED WITH TAPE, PLASTIC SHEET, METAL OR OTHER APPROVED METHOD TO REDUCE THE AMOUNT OF WATER, DUST AND DERRIS, WHICH MAY ENTER THE SYSTEM.
  - INTERIOR MOISTURE CONTROL - (CAL GREEN SECTION 4.505) BUILDING MATERIALS WITH VISIBLE SIGNS OF MOISTURE DAMAGE SHALL NOT BE INSTALLED. WALL AND FLOOR FRAMING SHALL NOT BE ENCLOSED WHEN THE FRAMING MEMBERS EXCEED 19 PERCENT MOISTURE CONTENT PER CAL GREEN SECTION 4.505.3. INSULATION PRODUCTS WHICH ARE VISIBLY WET OR HAVE A HIGH MOISTURE CONTENT SHALL BE REPLACED OR ALLOWED TO DRY PRIOR TO ENCLOSURE IN WALL OR FLOOR CAVITIES. WET- APPLIED INSULATION PRODUCTS SHALL FOLLOW THE MANUFACTURER'S DRYING RECOMMENDATIONS PRIOR TO ENCLOSURE. CONCRETE SLAB FOUNDATIONS REQUIRED TO HAVE A VAPOR RETARDER AND CAPILLARY BREAK.
  - INDOOR AIR QUALITY - (CAL GREEN SECTION 4.506) EACH BATHROOM SHALL BE MECHANICALLY VENTILATED WITH ENERGY STAR COMPLIANT FAN. THE FAN SHALL BE CONTROLLED BY A HUMIDITY CONTROL AND DUCTED OUTSIDE THE BUILDING. THE HUMIDITY CONTROL SHALL BE CAPABLE OF ADJUSTMENT BETWEEN A RELATIVE HUMIDITY RANGE OF 50TO 80 PERCENT. A HUMIDITY CONTROL MAY UTILIZED MANUAL OR AUTOMATIC MEANS OF ADJUSTMENT. A HUMIDITY CONTROL MAY BE A SEPARATE COMPONENTS TO THE EXHAUST FAN AND IS NOT REQUIRED TO BE INTEGRAL.
  - ENVIRONMENTAL COMFORT - (CAL GREEN SECTION 4.507) PERFORM RESIDENTIAL LOAD CALCULATIONS USING ANSI/ACCA 2 MANUAL J APPROVED METHODS OR SOFTWARE. SIZE DUCTING IN ACCORDANCE WITH ANSI/ACCA 1 MANUAL D. SELECT COOLING EQUIPMENT ACCORDING TO ANSI/ACCA 3 MANUAL S.

## CA PLUMBING CODE NOTES

- GENERAL
- PROVIDE A BACK FLOW PREVENTION DEVICE AT ALL HOSE BIBS AND WATER SUPPLY LINES. (CPC SECTION 603.3)
  - SHOWERS AND SHOWER/ TUB COMBINATIONS SHALL HAVE INDIVIDUAL CONTROL VALVES OF THE PRESSURE BALANCE, THERMOSTATIC OR COMBINATION PRESSURE BALANCE/THERMOSTATIC MIXING VALVE TYPE. PROVIDE TEMPERATURE REGULATION TO LIMIT HOT WATER TEMPERATURE TO 120°F. THE WATER HEATER THERMOSTAT SHALL NOTE CONSIDERED APPROPRIATE MEANS. (CPC SECTION 608.3)
  - WATER CLOSET STOOL SHALL BE LOCATED MINIMUM 15" FROM ITS CENTER TO ANY SIDEWALL OR OBSTRUCTION (MINIMUM 30" CLEAR SPACE IN WIDTH) AND HAVE A CLEAR SPACE IN FRONT OF THE WATER CLOSET NOT LESS THAN 24". (CPC 402.5)



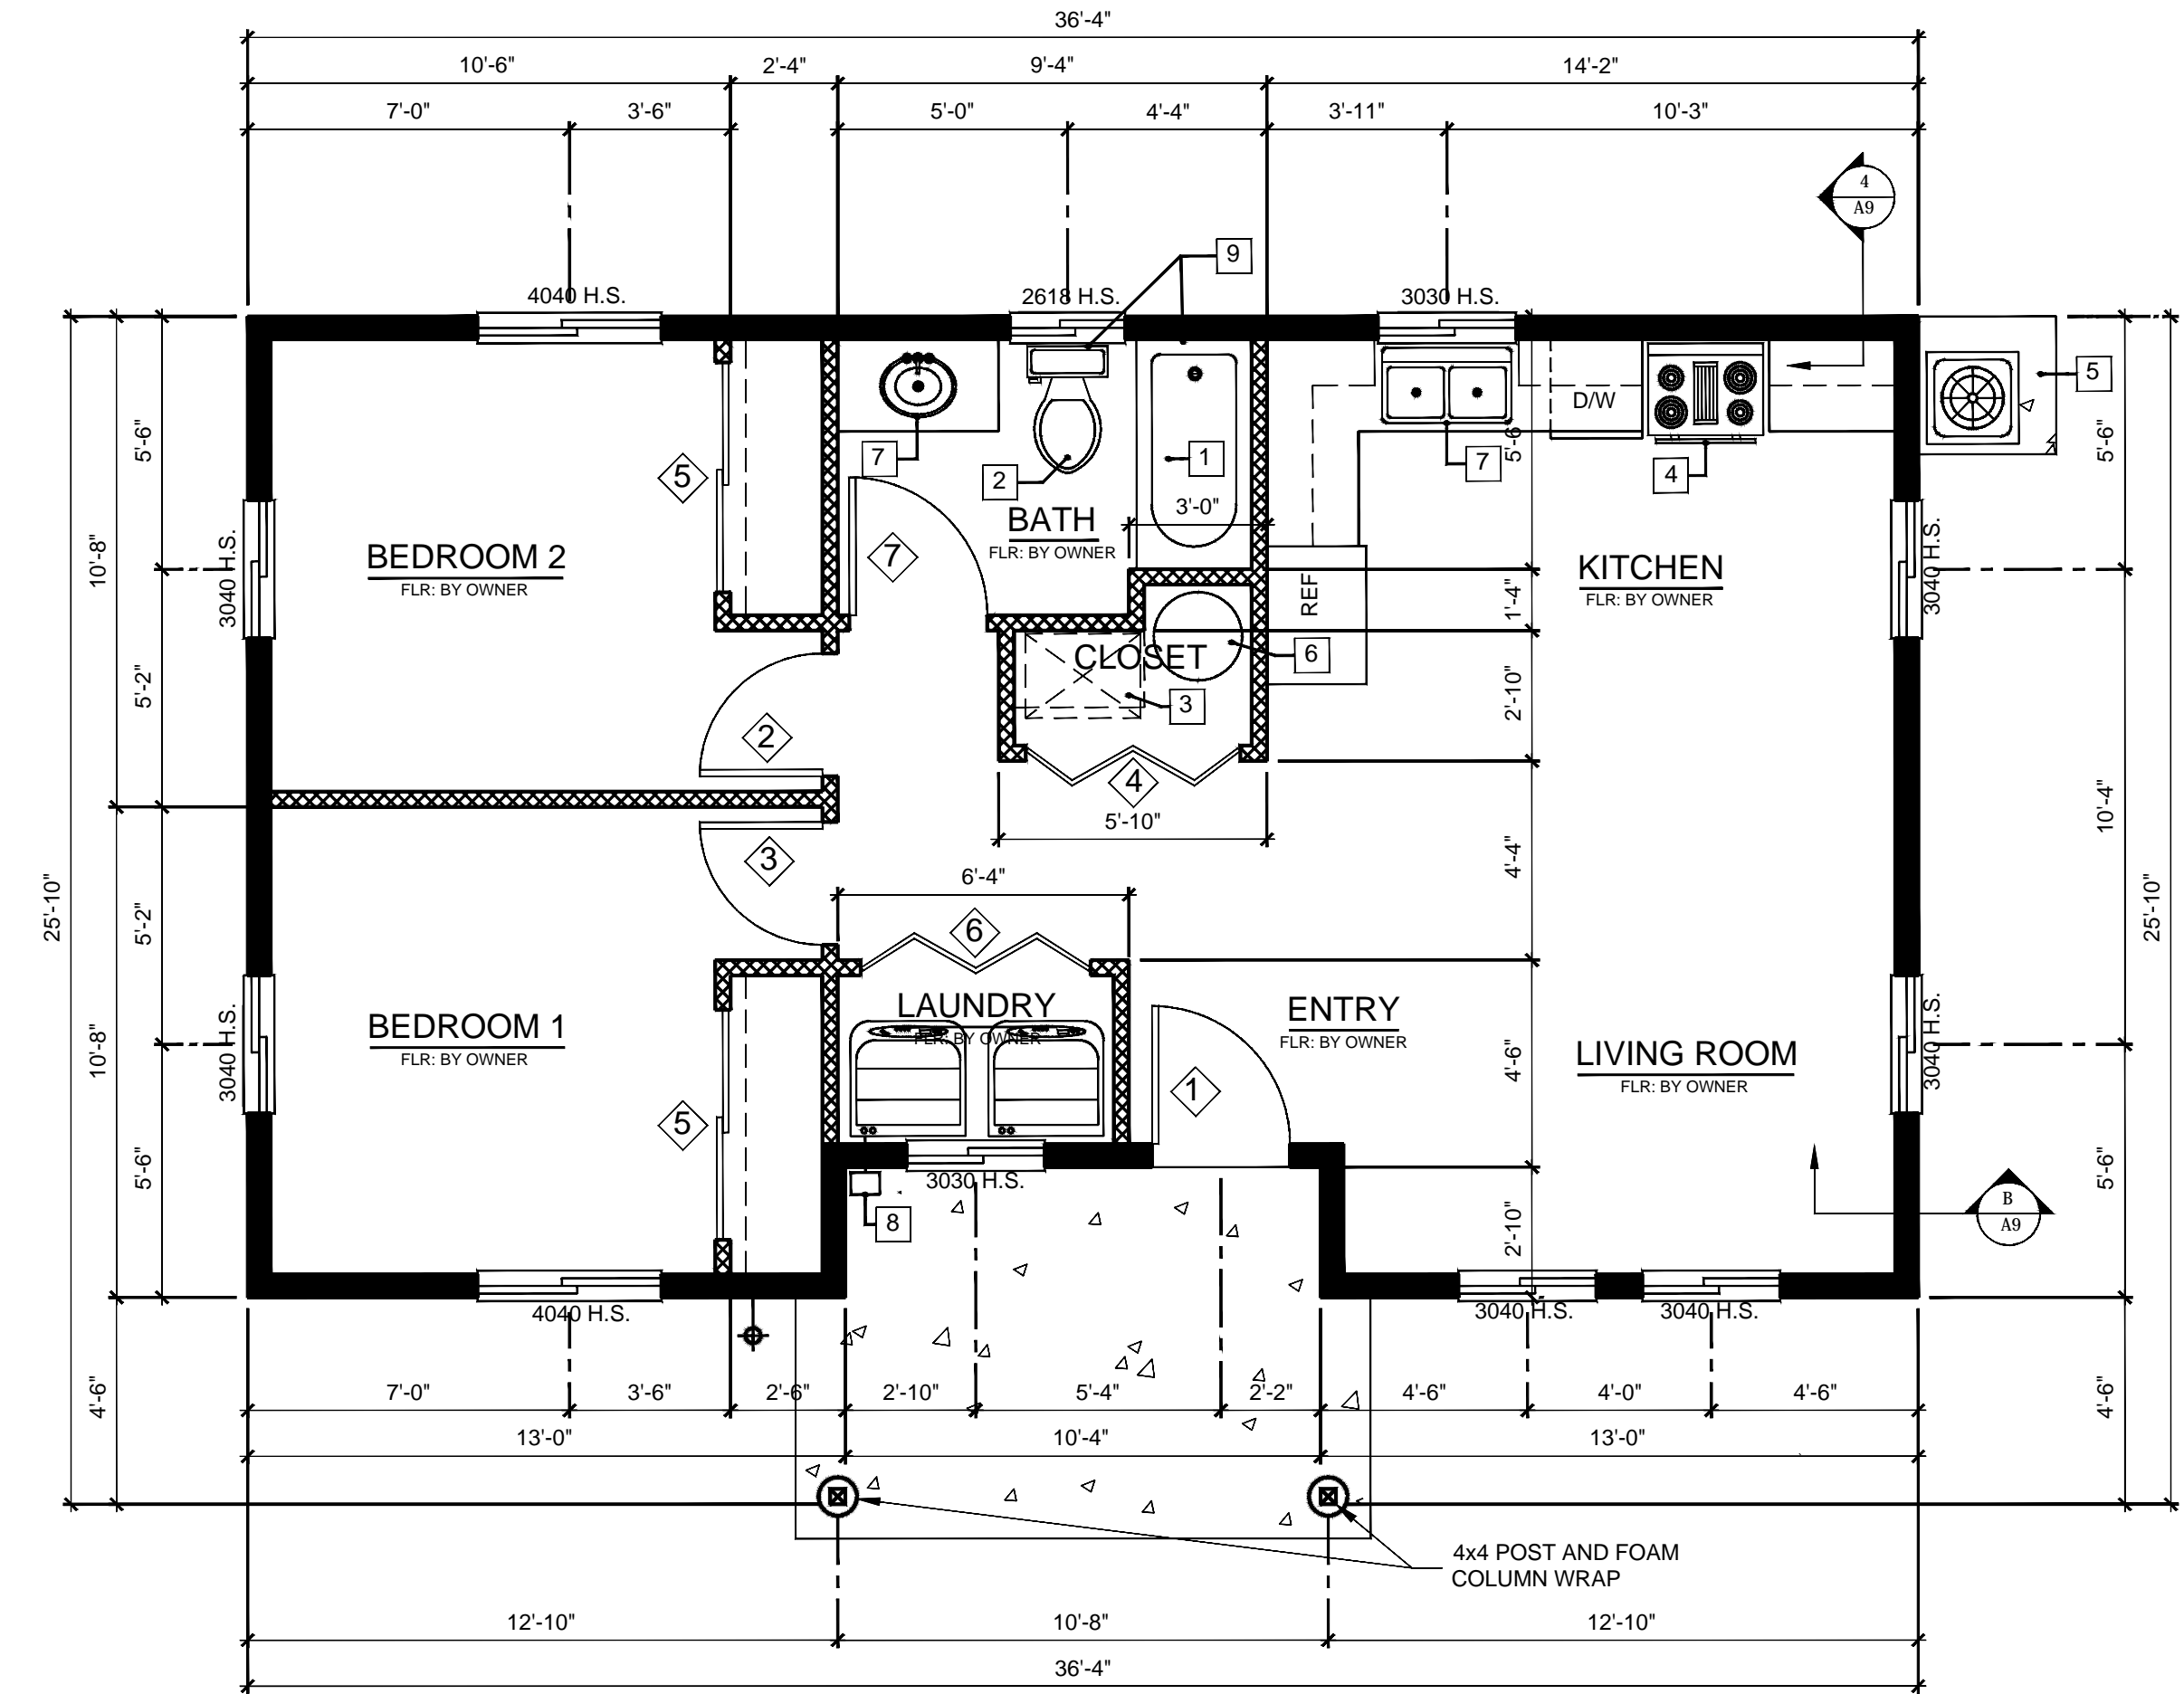

FLOOR PLAN

WALL LEGEND	
	EXTERIOR WALL - 2x4 D.F. #2 WOOD STUDS @ 16" O.C.
	INTERIOR WALL - 2x4 D.F. #2 WOOD STUDS @ 16" O.C.

DOOR AND FRAME SCHEDULE				
SYMBOL	SIZE			
	WD	HGT	THK	STYLE
	3'-0"	6'-8"	1 3/4"	L.H.
	2'-8"	6'-8"	1 3/8"	L.H.
	3'-0"	6'-8"	1 3/8"	R.H.
	PR 2'-4"	6'-8"	1 3/8"	LOUVERED
	PR 2'-6"	6'-8"	1 3/8"	SLIDER
	PR 2'-6"	6'-8"	1 3/8"	LOUVERED
	3'-0"	6'-8"	1 3/8"	L.H.

NOTE:  
(1) ALL HEADERS AT EXTERIOR DOOR AND WINDOW OPENINGS SHALL BE 4x8 D.F. #2 MIN.  
(2) WINDOWS IN BEDROOMS THAT ARE A PART OF EMERGENCY EGRESS ESCAPE RESCUE OPENING REQUIREMENTS SHALL HAVE A SILL HEIGHT NO MORE THAN 44" ABOVE FINISHED FLOOR.

FLOOR PLAN LEGEND	
	60"x30" TUB/SHOWER UNIT SHOWER HEAD 1.8 GPM
	TOILET 1.28 GPF
	22"x30" ATTIC ACCESS PANEL
	RANGE W/ MICROWAVE ABOVE/ EXH. HOOD
	3'x3' CONCRETE PAD FOR AC CONDENSER, SHOWN FOR REFERENCE ONLY, LOCATE IN FIELD PER MANF. SPECS
	ELECTRIC HEAT PUMP WATER HEATER, INSTALLED PER MANUFACTURER'S SPECIFICATIONS
	LAVATORY / SINK, 1.2 GPM / 1.8 GPM
	EXHAUST FOR DRYER
	PROVIDE GRAB BAR REINFORCEMENT AT TOILET AND TUB/SHOWER, SEE NOTES ON SHEET A6

NOTE:  
(1) ALL FIXTURES AND APPLIANCES SHALL BE SELECTED BY OWNER AND SHALL BE IN CONFORMANCE WITH THESE PLANS.

SCALE: 1/4" = 1'-0"

By using these standard plans, the user agrees to release San Joaquin County from any and all claims, liabilities, suits, and demands on account of any injury, damage, or loss to persons or property, including injury or death, or economic losses, arising out of the use of these construction documents. The use of these plans does not eliminate or reduce the user's responsibility to verify any and all information.




Sheet Number

# A2

# ELECTRICAL PLAN

NOTE: ALL RECEPTACLE OUTLETS SHALL BE TAMPER RESISTANT



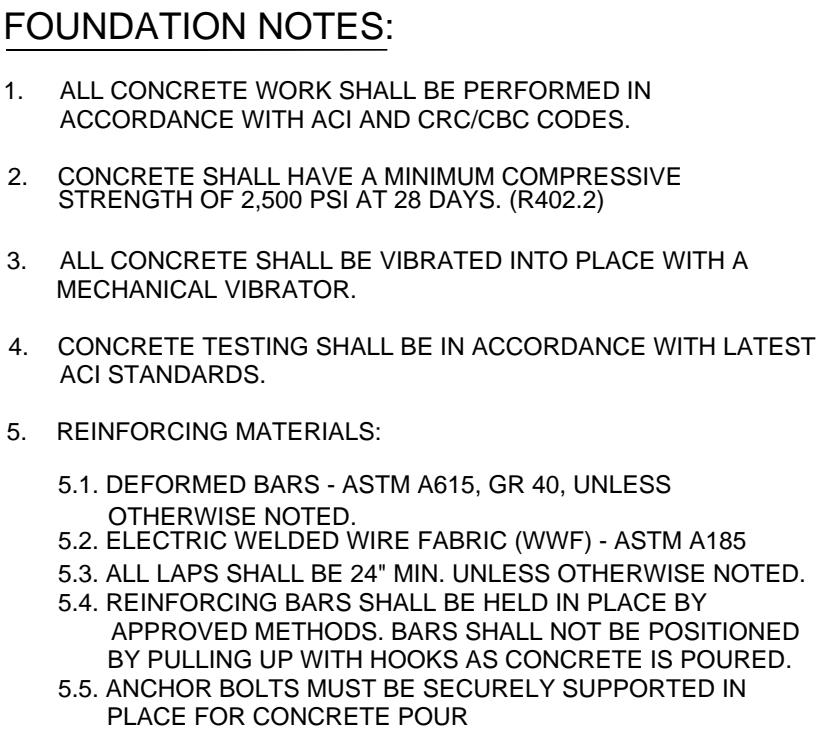

SCALE: 1/4" = 1'-0"

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**FOUNDATION PLAN**  
San Joaquin County, Planning & Development Services  
**746 SF ACCESSORY DWELLING 2-BEDROOM UNIT**  
***BUILDING DIVISION***  
DATE REVISED: MAY, 2025



COS  
VERSION: 3.0

Sheet Number


# A3

BRACED WALL PANEL SUMMARY								
BWL	METHOD	MATERIAL & MIN. THICKNESS	BWL LENGTH	BWL SPACING	WALL HEIGHT	ADJUSTMENT FACTOR	REQUIRED LENGTH	PROVIDED LENGTH
1	CS-WSP	3/8" OSB	36'-4"	21'-4"	8'-0"	1.0	8.5'	26.83'
2	CS-WSP	3/8" OSB	36'-4"	21'-4"	8'-0"	1.0	8.5'	15'
A	CS-WSP	3/8" OSB	21'-4"	16'-4"	8'-0"	1.0	6.4'	15.33'
B	CS-WSP	3/8" OSB	18'-6"	20'-0"	8'-0"	1.0	4.3'	10'
C	CS-WSP	3/8" OSB	21'-4"	20'-0"	8'-0"	1.0	6.4'	15.33'

NOTE: BRACED WALL PANEL REQUIREMENTS WERE DERIVED USING WORSE CASE SCENARIO SEISMIC DESIGN CATEGORY D2.

BRACED WALL PANEL SCHEDULE				
METHOD	MINIMUM THICKNESS	FASTENERS	EDGE	FIELD
CS-WSP	3/8" OSB	EXTERIOR SHEATHING PER CRC TBL. R602.3(3)	6" O.C.	12" O.C.
		INTERIOR SHEATHING PER CRC TBL. R602.3(1) OR R602.3(2)	6" O.C.	6" O.C.

NOTE: SEE DETAIL 6/A9 FOR ANCHOR BOLT SIZE AND SPACING.

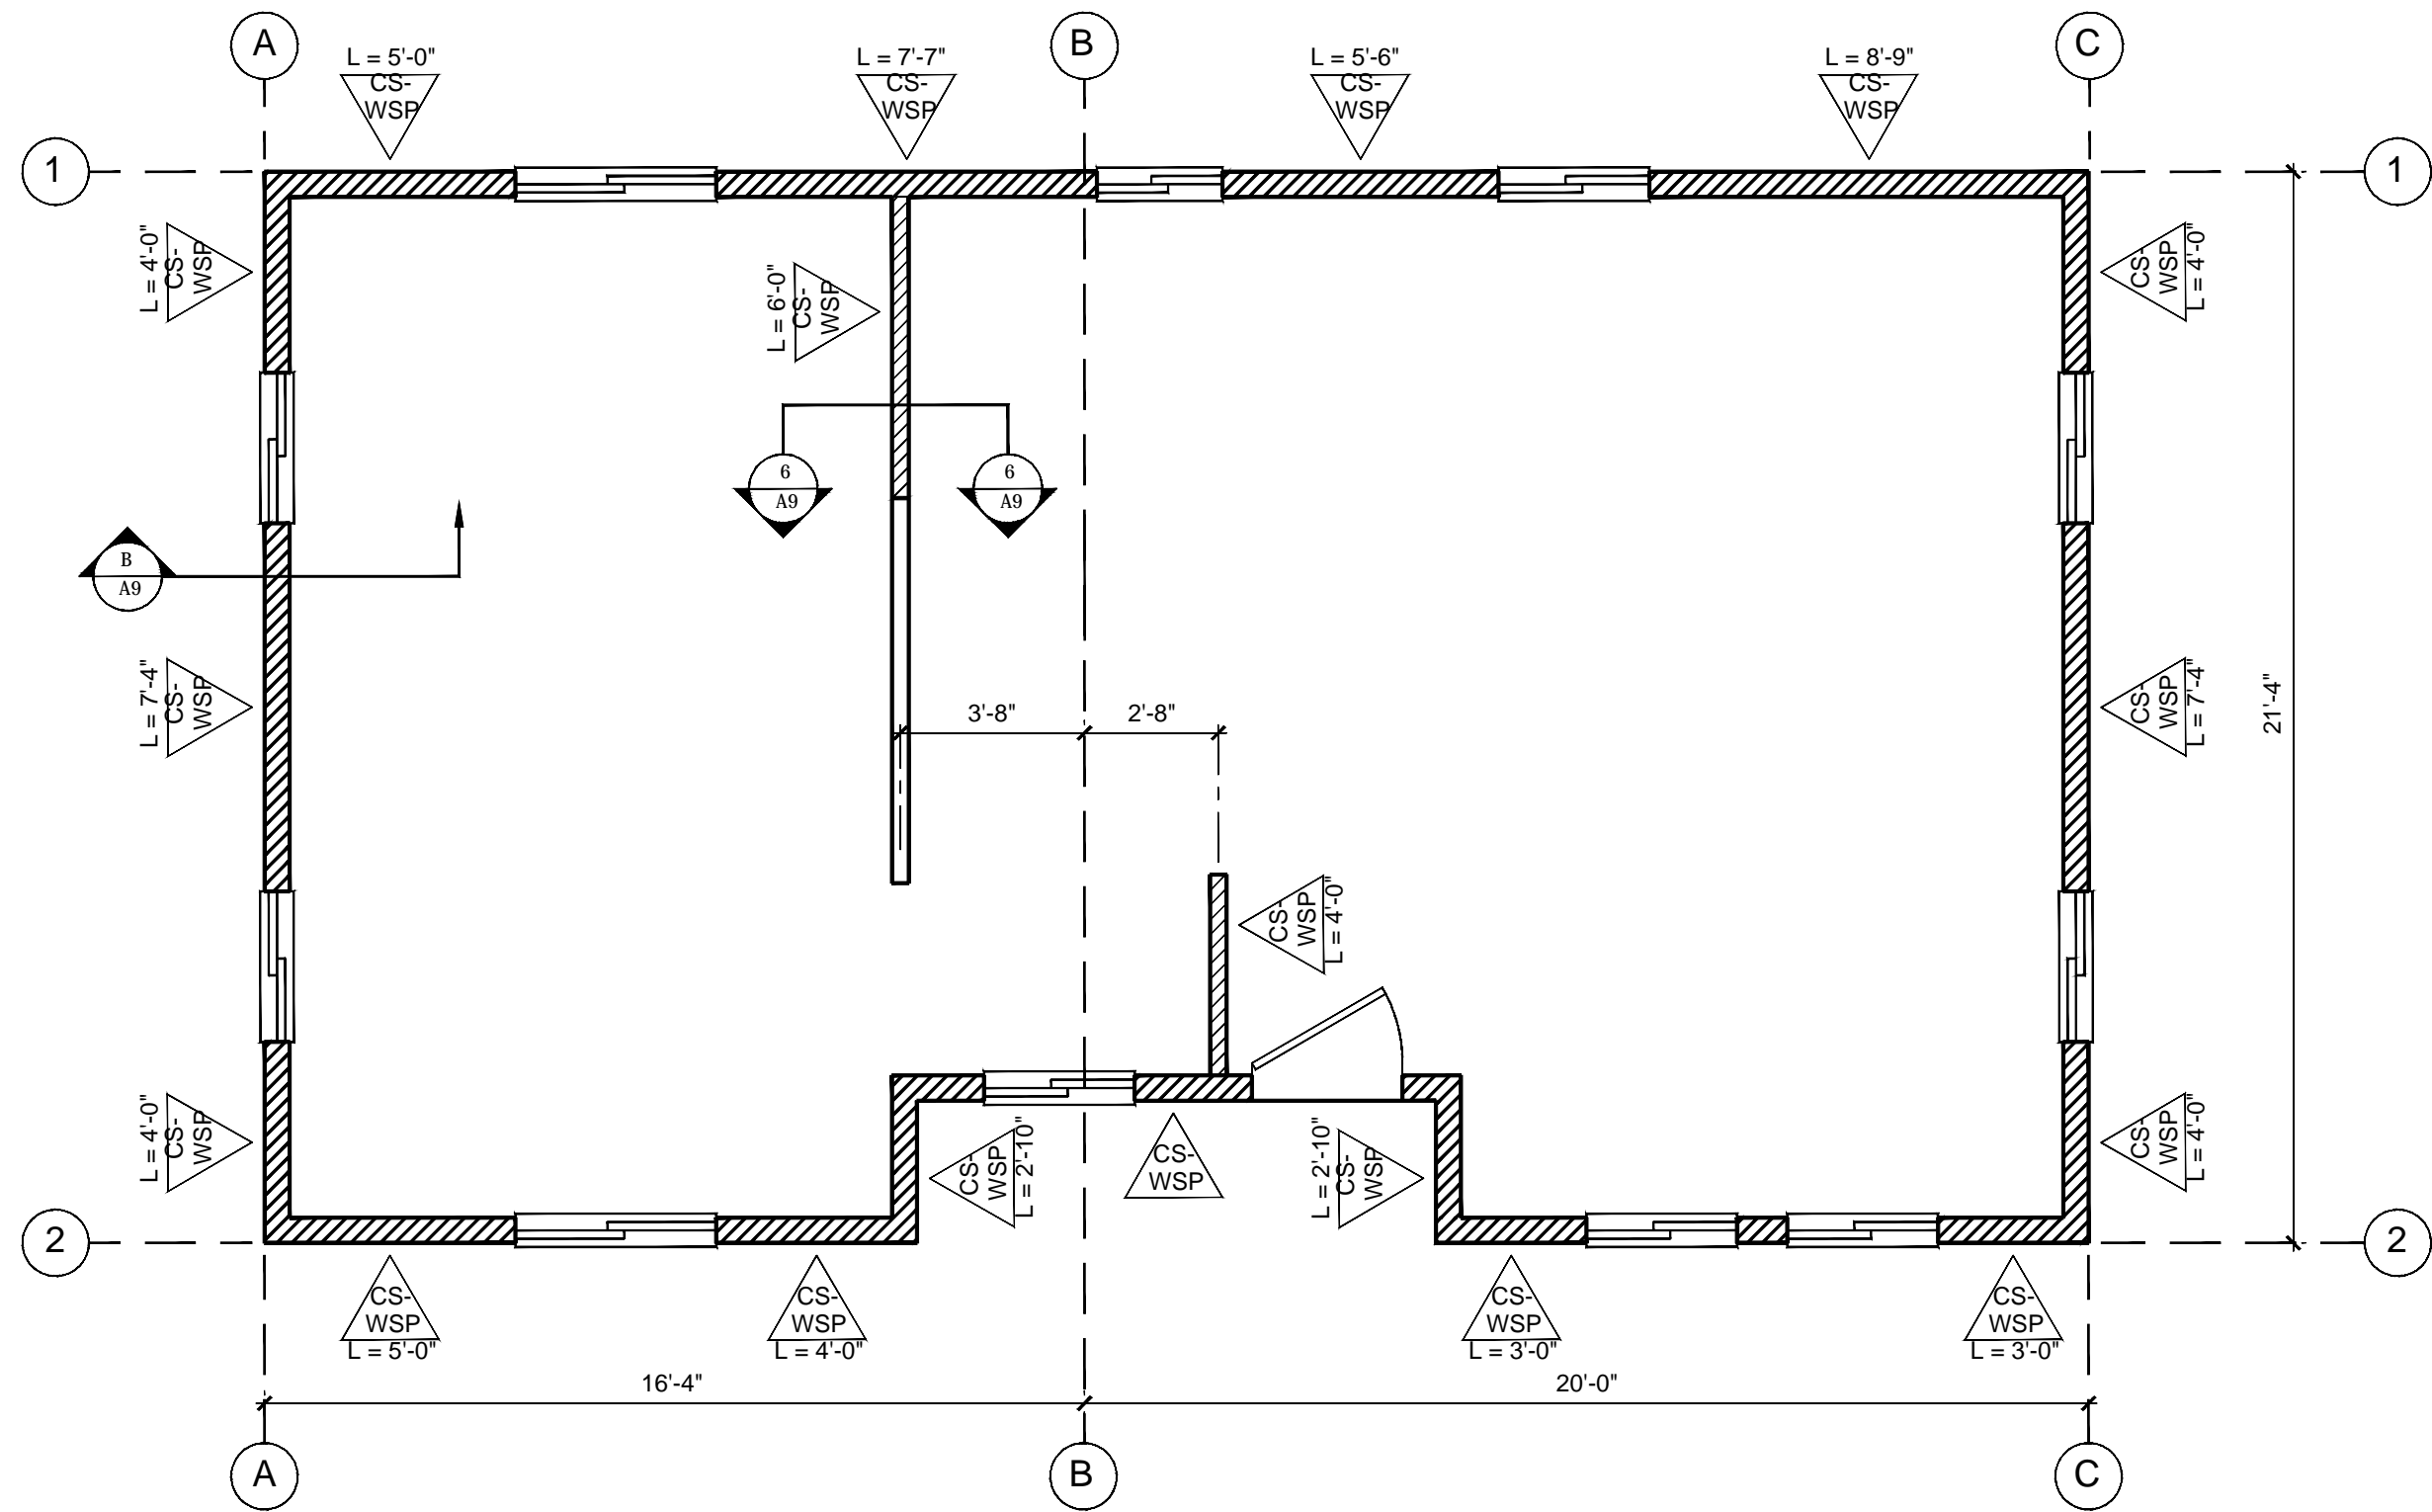

BRACED WALL PLAN

SCALE: 1/4" = 1'-0"

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**Sheet Number**

# A5

# ROOF FRAMING PLAN

SCALE: 1/4" = 1'-0"




**Sheet Number**

## CEILING FRAMING PLAN

**746 SF ACCESSORY DWELLING 2-BEDROOM UNIT**


DATE REVISED: MAY, 2025

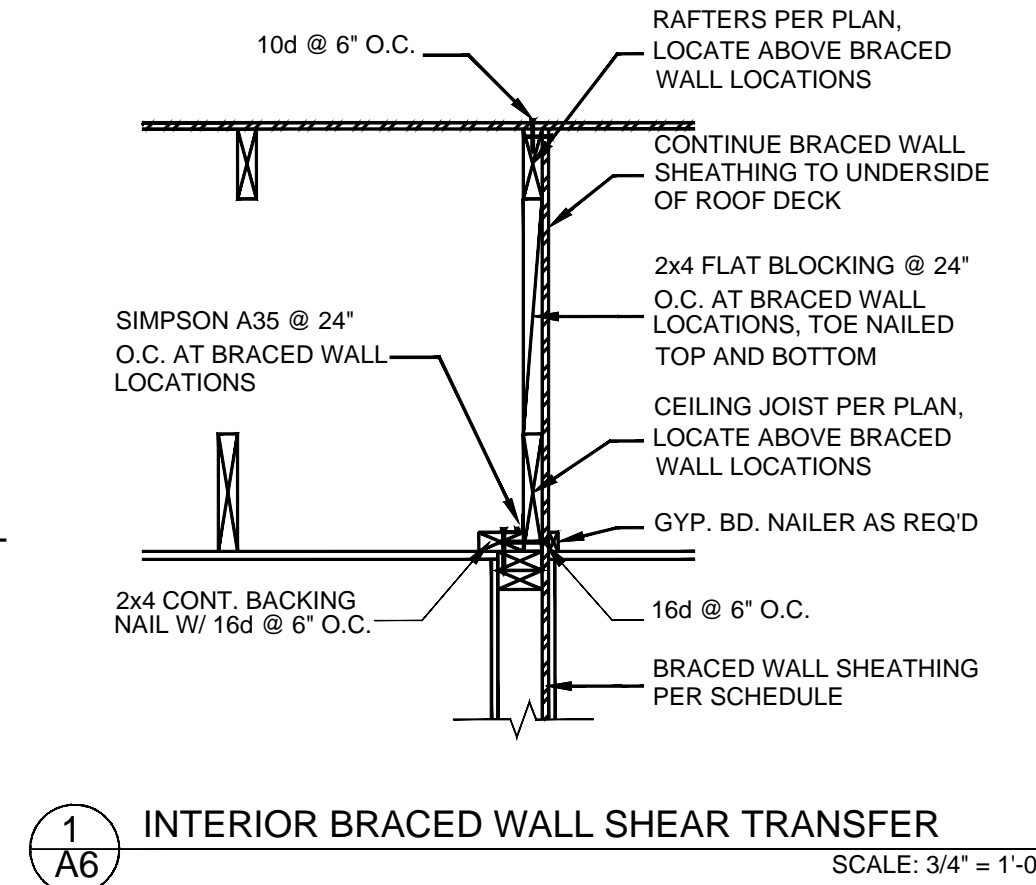

1. REINFORCEMENT SHALL BE SOLID LUMBER.
2. REINFORCEMENT SHALL BE MIN. 2x8 NOMINAL LUMBER LOCATED BETWEEN 32" AND 39-1/4" ABOVE THE FINISHED FLOOR FLUSH WITH THE WALL FRAMING.
3. REINFORCEMENT AT THE TOILET SHALL BE INSTALLED ON BOTH SIDE WALLS OF THE FIXTURE OR ONE SIDE WALL AND THE BACK WALL, WHERE THE TOILET IS NOT ADJACENT TO A SIDE WALL, PROVIDE ADDITIONAL REINFORCEMENT AT THE BACK WALL TO FACILITATE A FOLD-DOWN OR SIMILAR TYPE GRAB BAR.
4. SHOWER REINFORCEMENT SHALL BE CONTINUOUS WHERE WALL FRAMING IS PROVIDED.
5. BATHTUB AND COMBINATION TUB/SHOWER REINFORCEMENT SHALL BE CONTINUOUS ON EACH END OF THE TUB AND THE BACK WALL. ADDITIONALLY, BACK WALL REINFORCEMENT FOR A LOWER GRAB BAR SHALL BE PROVIDED WITH THE BOTTOM EDGE LOCATED NO MORE THAN 6" ABOVE THE TUB RIM.

SCALE: 1/4" = 1'-0"



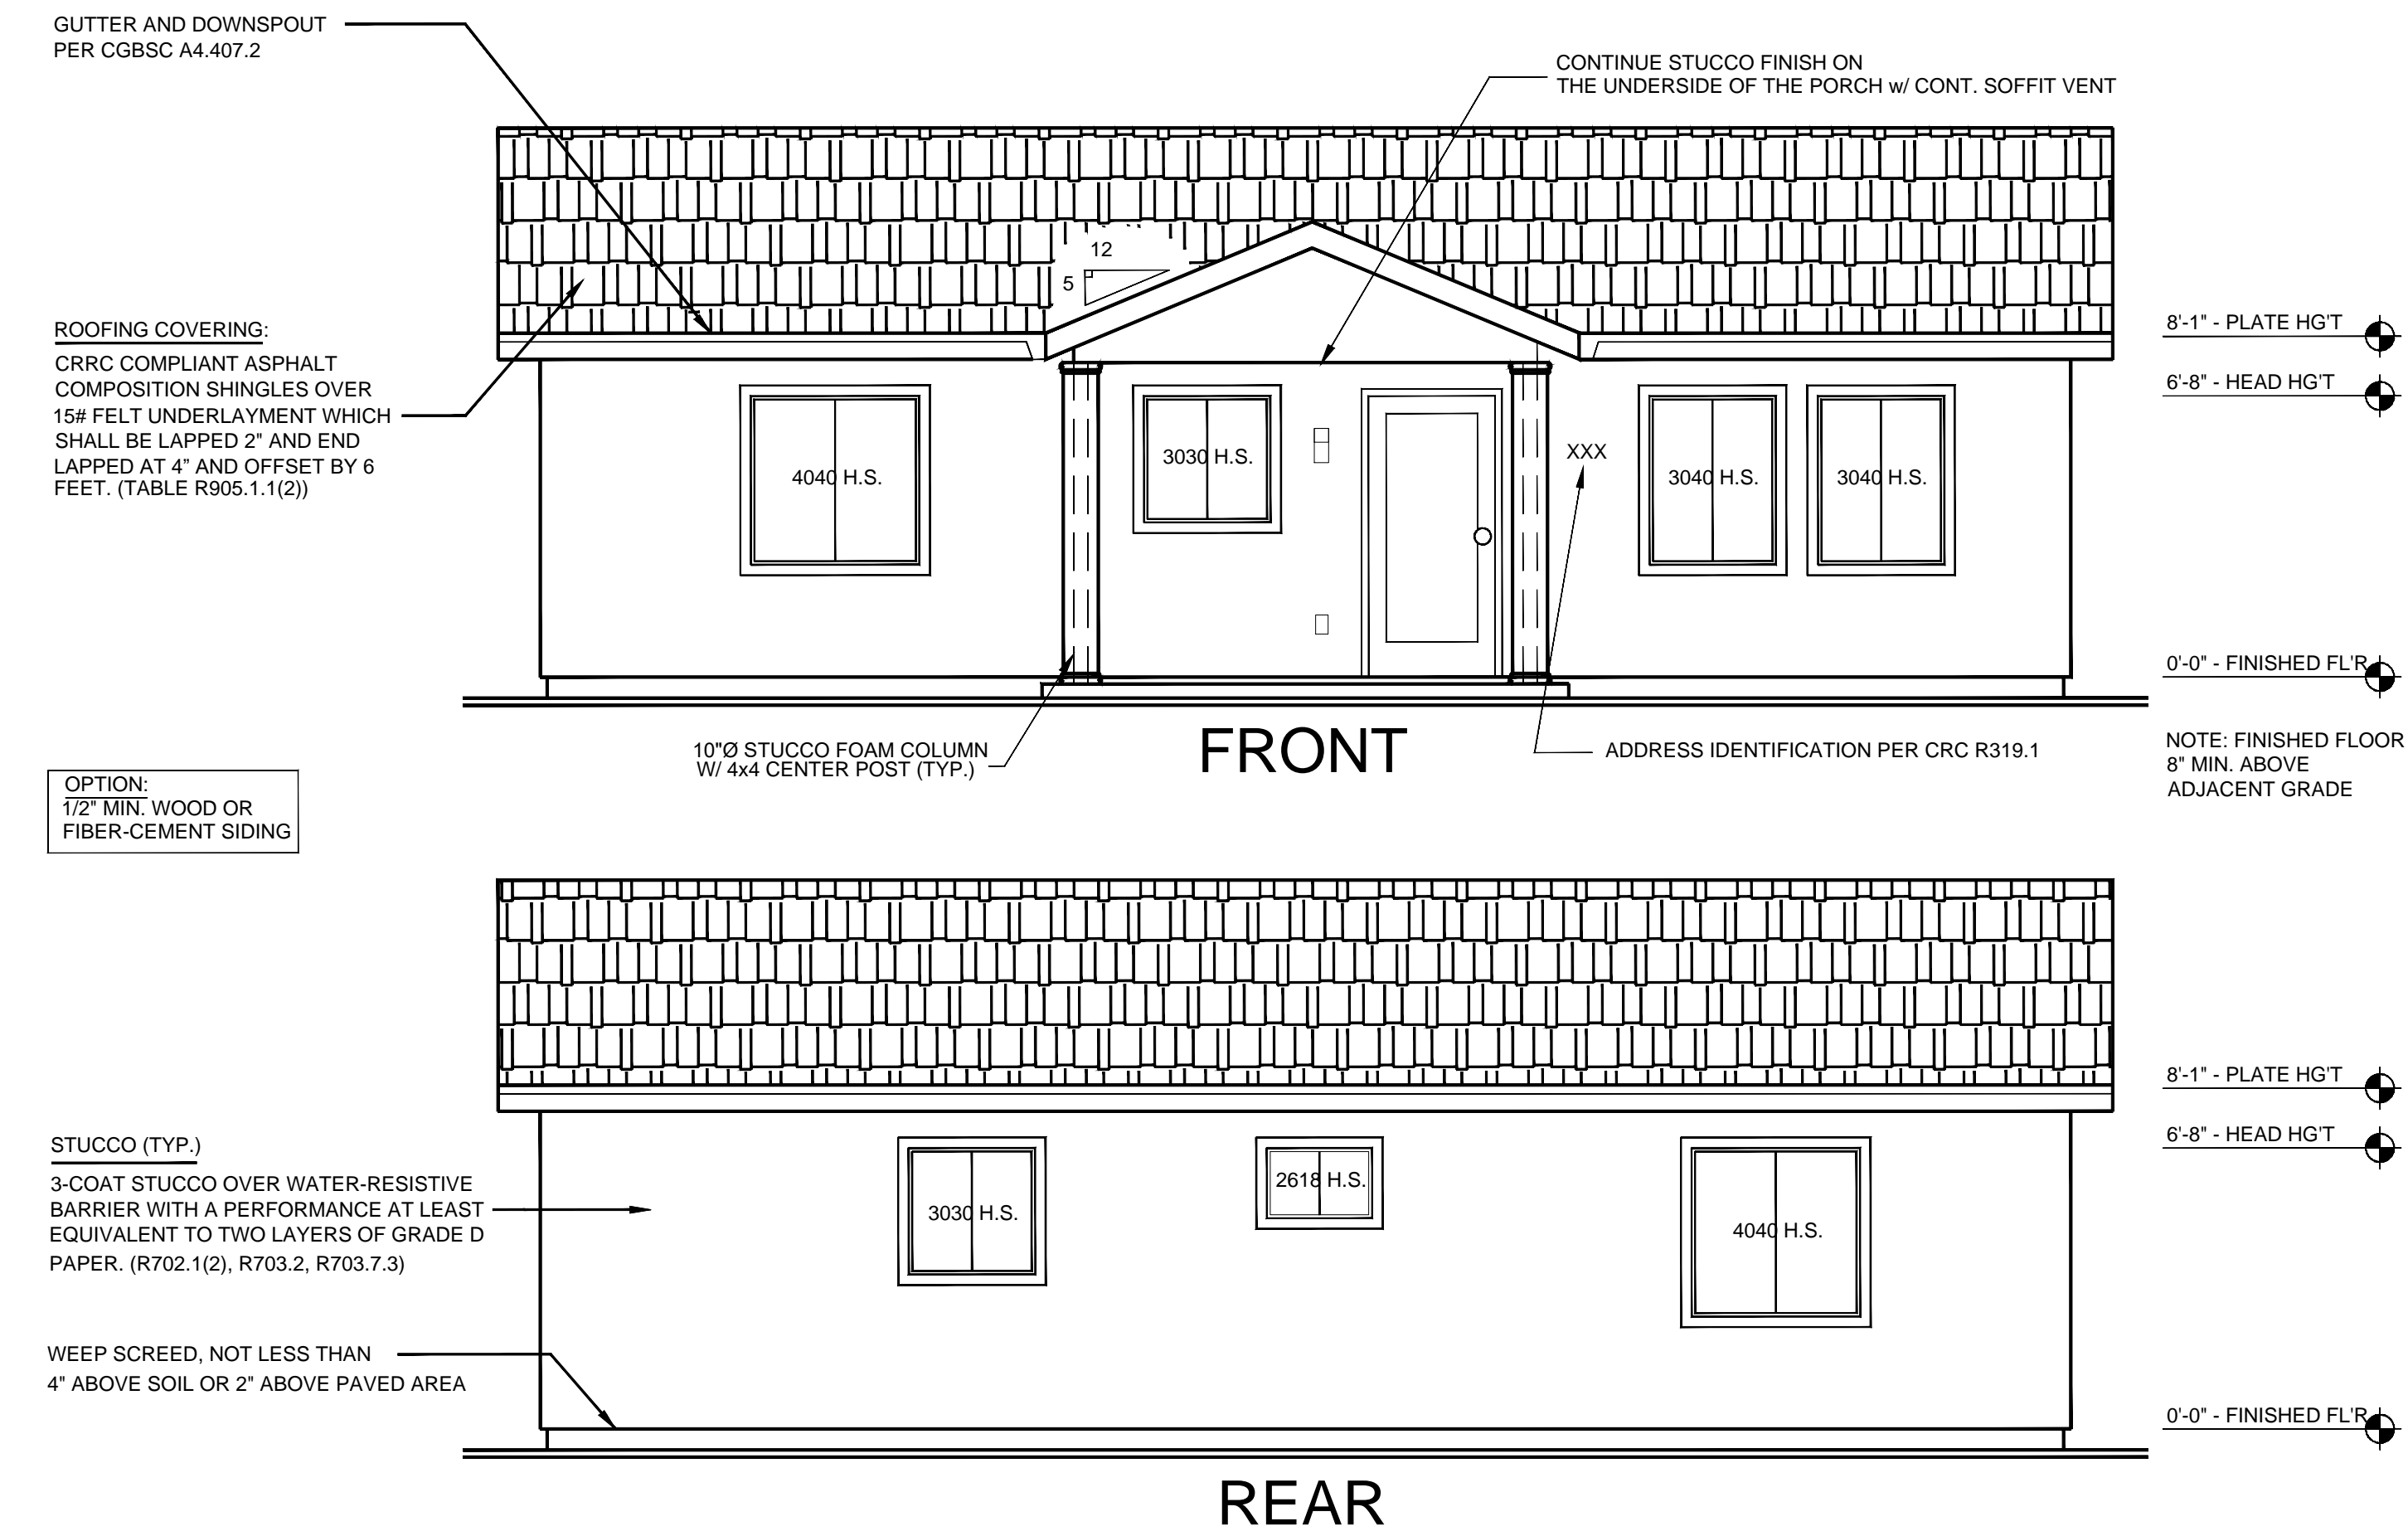

ELEVATIONS

SCALE: 1/4" = 1'-0"

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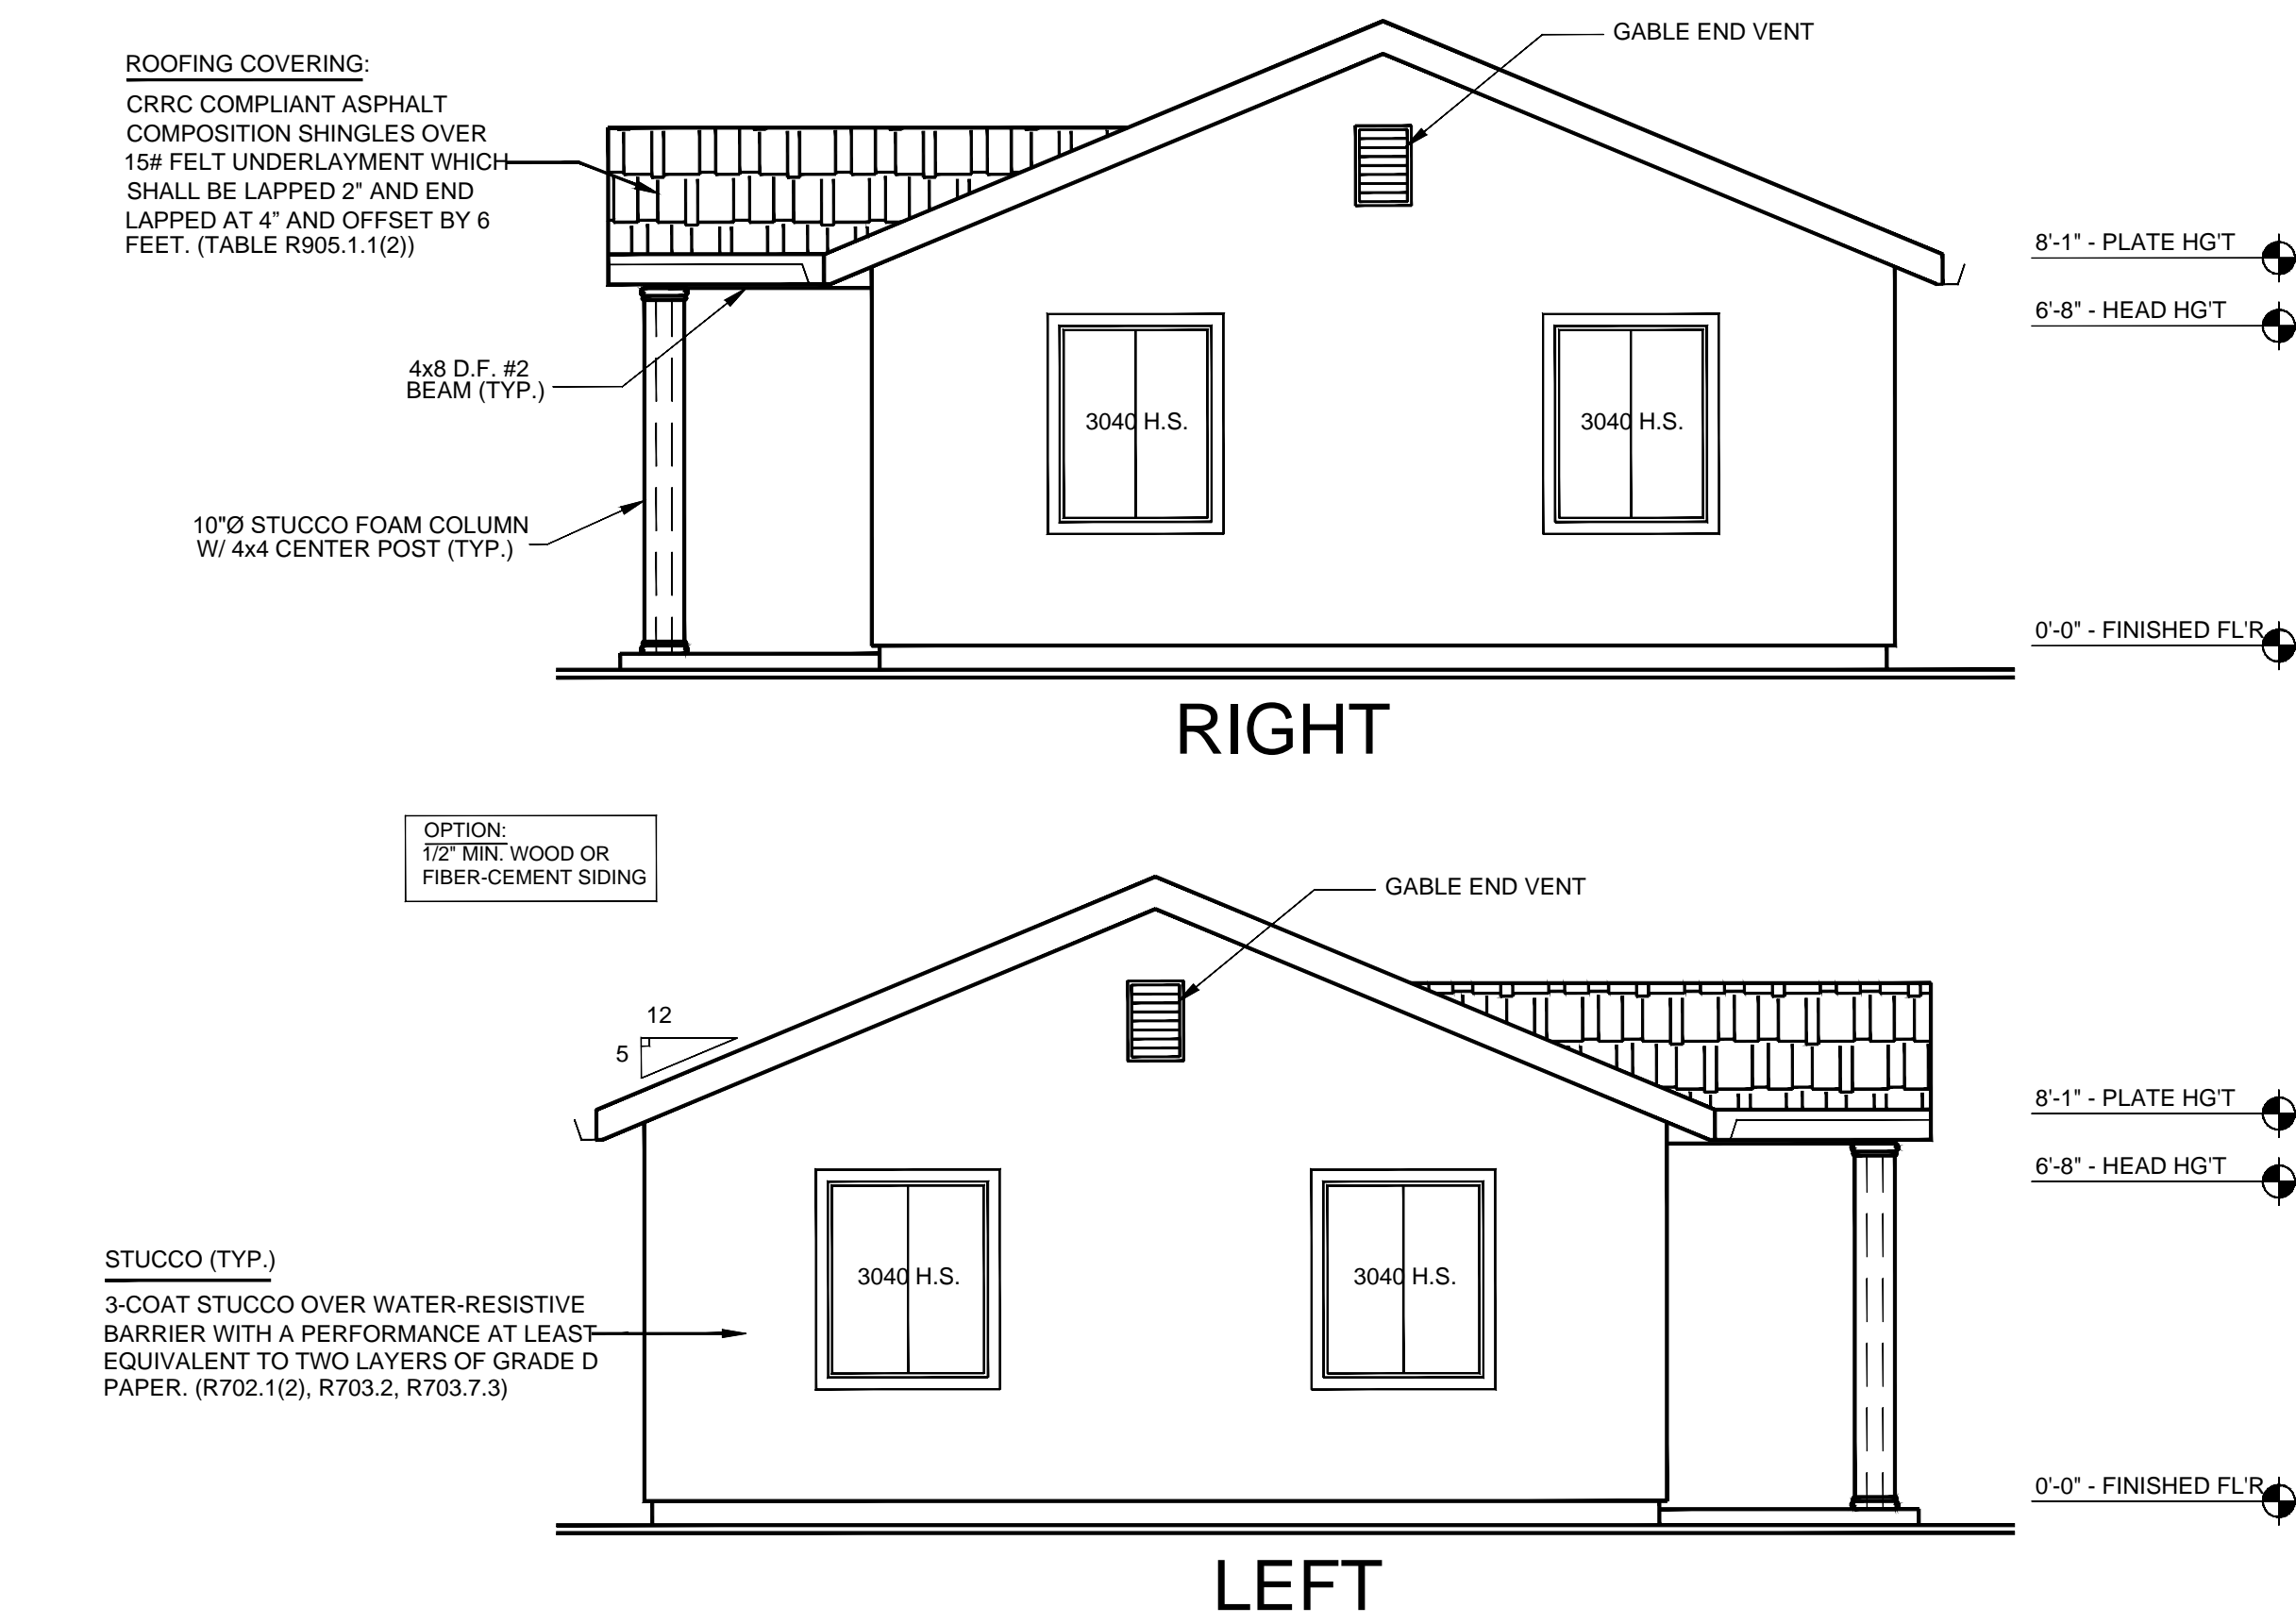
FRONT AND REAR ELEVATIONS  
San Joaquin County, Planning & Development Services  
746 SF ACCESSORY DWELLING 2-BEDROOM UNIT  
BUILDING DIVISION  
DATE REVISED: MAY, 2025



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Sheet Number

A7



GA FILE NO. WP 8105

**1-HOUR FIRE-RATED WALL:**  
IF EXTERIOR WALL OF ADU IS WITHIN 5-FEET OF P.L. (NON-SPRINKLERED) OR 3-FEET OF P.L. (SPRINKLERED), PROVIDE FIRE-RATED WALL IN ACCORDANCE W/ THIS DETAIL.

**EXTERIOR SIDE:** One layer 48" wide 5/8" type X gypsum sheathing applied parallel to 2x6 studs 16" o.c. w/ 1-3/4" galv. roofing nails 4" o.c. at vertical joints and 7" o.c. at intermediate studs and top & bot. plates. Joints may be left untreated. Exterior finish as applicable, all attachments through sheathing to studs.

**INTERIOR SIDE:** One layer 5/8" type X gypsum wallboard or water-resistant gypsum backing board applied parallel or at right angles to studs w/ 6D coated nails 1-7/8" long, 0.0915" shank, 1/4" heads 7" o.c.

**1-HOUR FIRE-RATED EXT. WALL**  
NOT TO SCALE

**FIRE-RATED PROJECTIONS:**  
IF ROOF OVERHANG(S) OF ADU IS BETWEEN 2-FEET TO 5-FEET OF P.L. (NON-SPRINKLERED) OR 2-FEET TO 3-FEET OF P.L. (SPRINKLERED), PROVIDE 1-HOUR FIRE-RATING AT UNDERSIDE IN ACCORDANCE W/ THIS DETAIL.

**1-HOUR FIRE-RATED PROJECTION**  
NOT TO SCALE

FIRE-TREATED WOOD PANEL OR TYPE X GYPSUM SHEATHING AT UNDERSIDE OF EAVE

CONTINUE STUCCO FINISH AT EAVE

EXTERIOR WALL ASSEMBLY, PER PLANS OR DETAIL ABOVE

SOLID BLOCKING, NO EAVE VENTS

## ELEVATIONS

SCALE: 1/4" = 1'-0"

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**LEFT AND RIGHT ELEVATIONS**  
San Joaquin County, Planning & Development Services  
**746 SF ACCESSORY DWELLING 2-BEDROOM UNIT**  
**BUILDING DIVISION**  
DATE REVISED: MAY, 2025




COS  
VERSION: 3.0


Sheet Number

**A8**




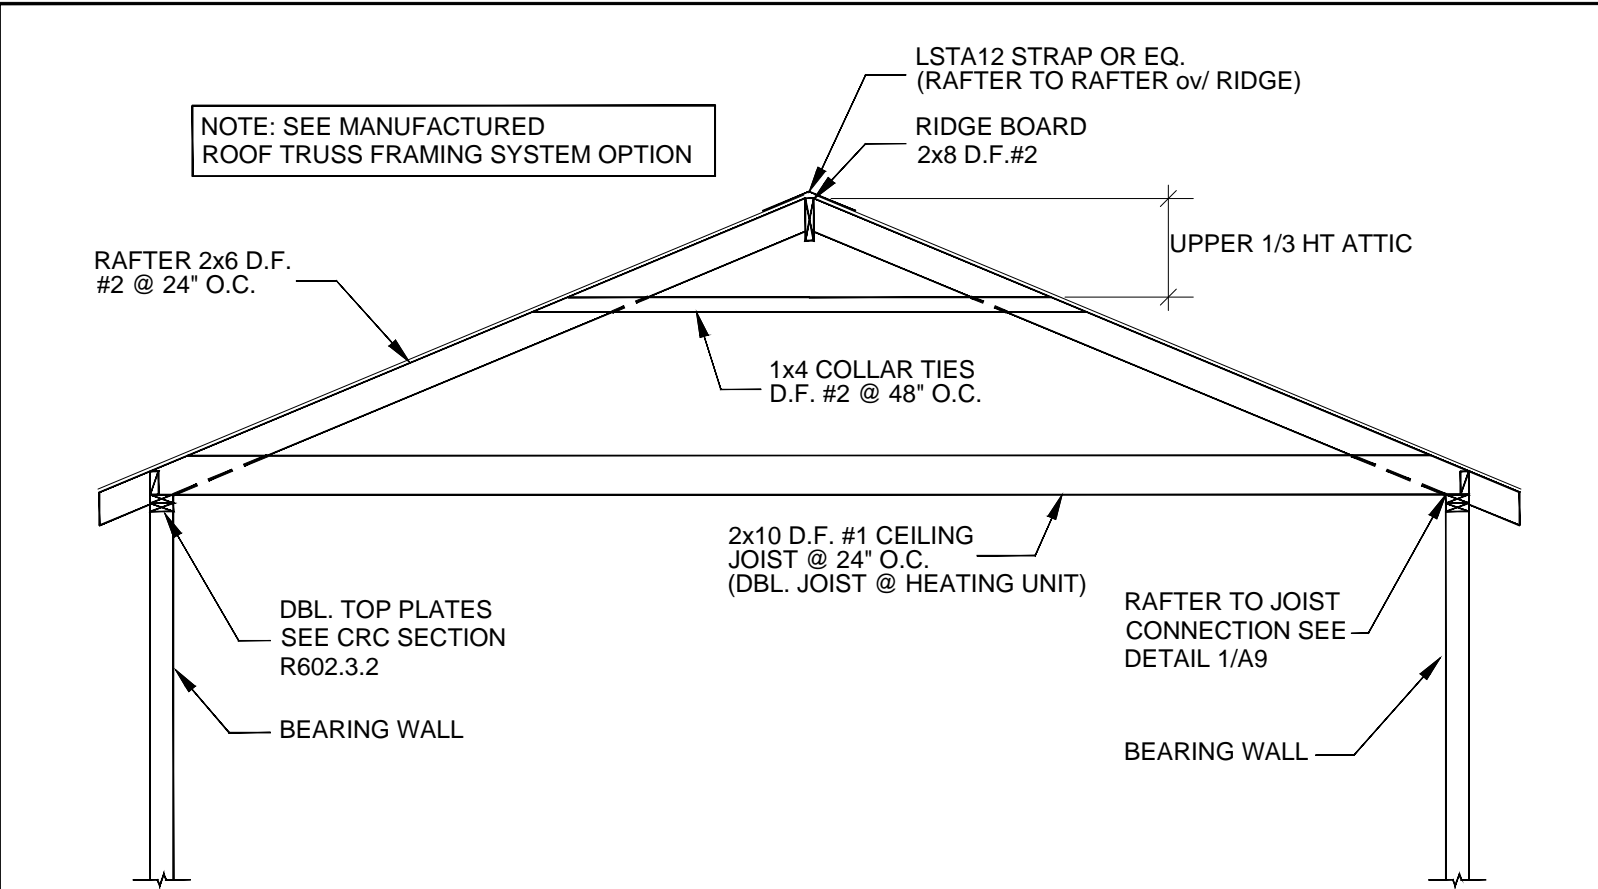


**A9** BRACED RAFTER CONSTRUCTION  
SCALE: 1/4" = 1'-0"

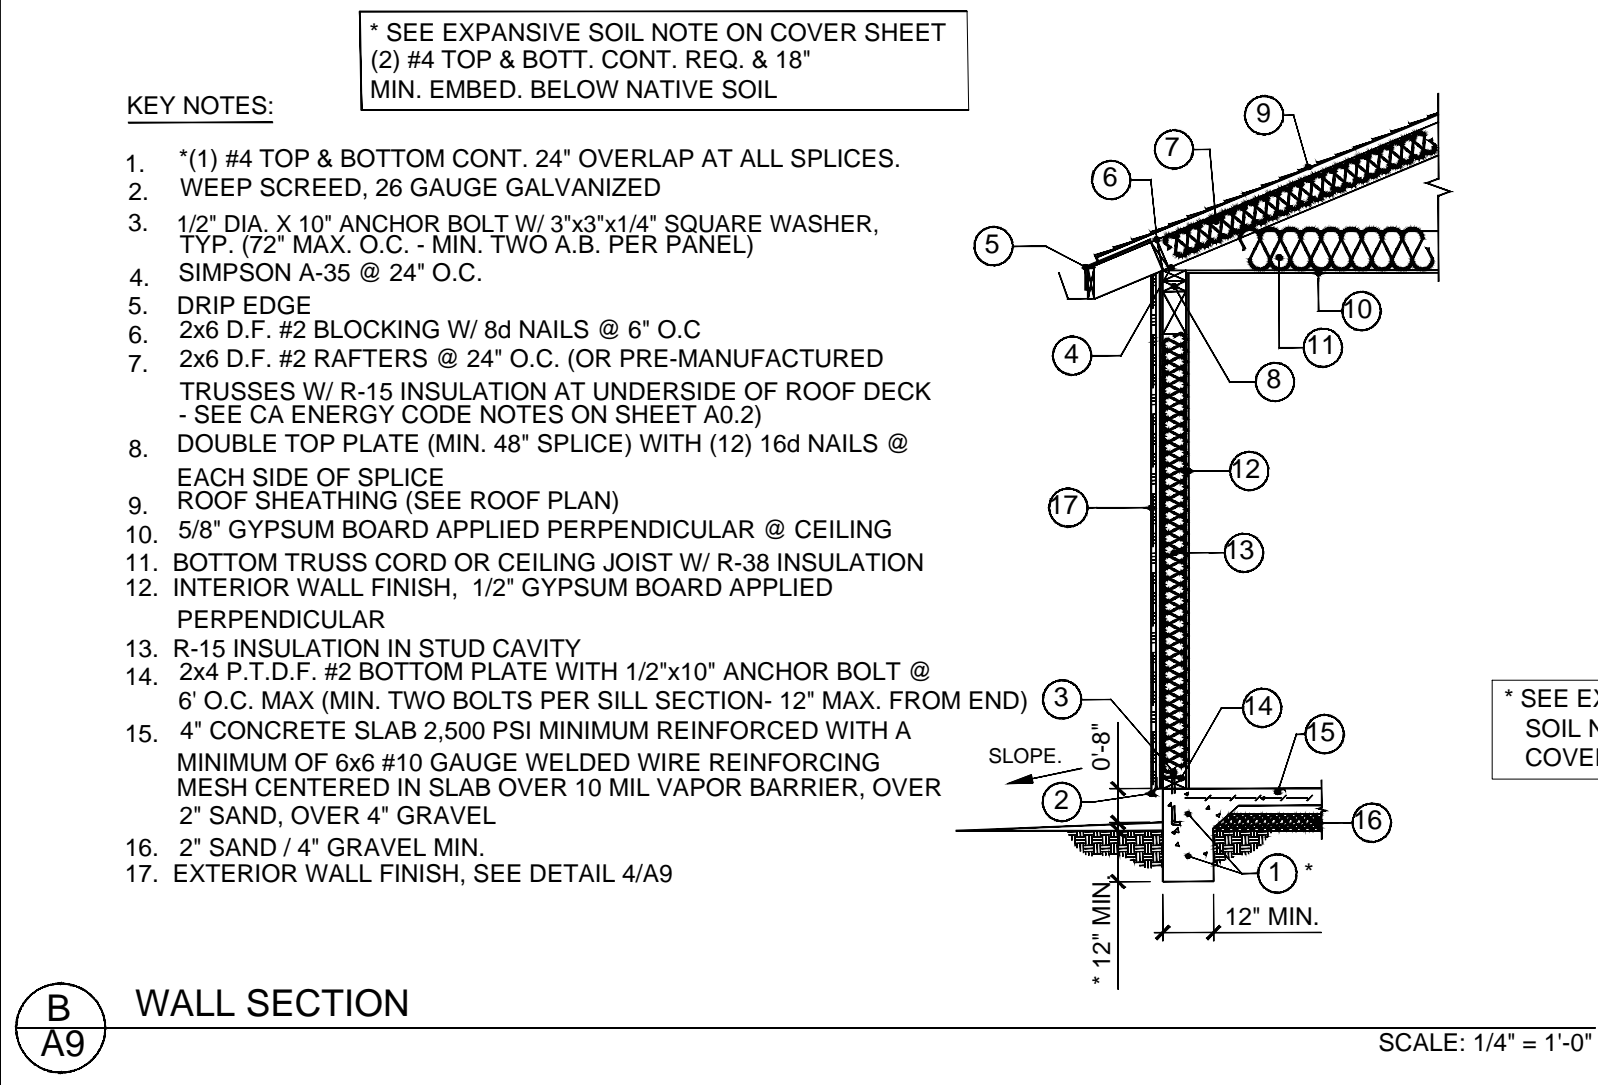


**B A9** WALL SECTION  
SCALE: 1/4" = 1'-0"

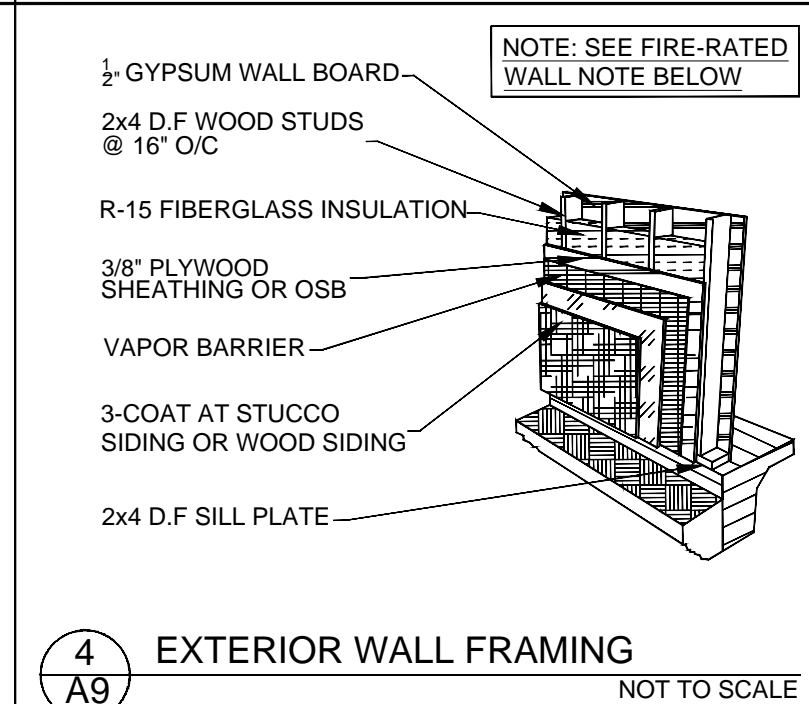


**4 A9** EXTERIOR WALL FRAMING  
NOT TO SCALE

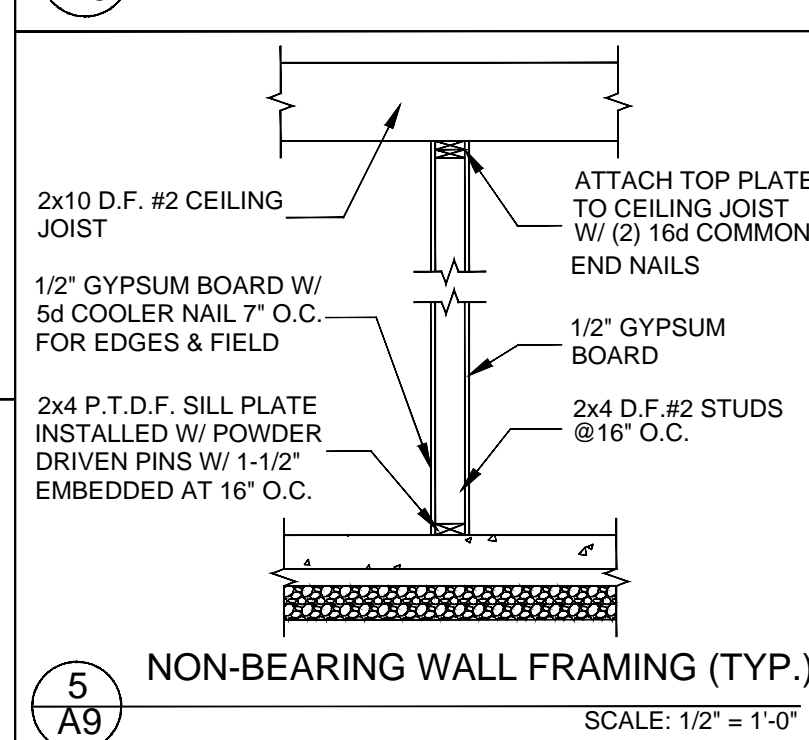


**5 A9** NON-BEARING WALL FRAMING (TYP.)  
SCALE: 1/2" = 1'-0"

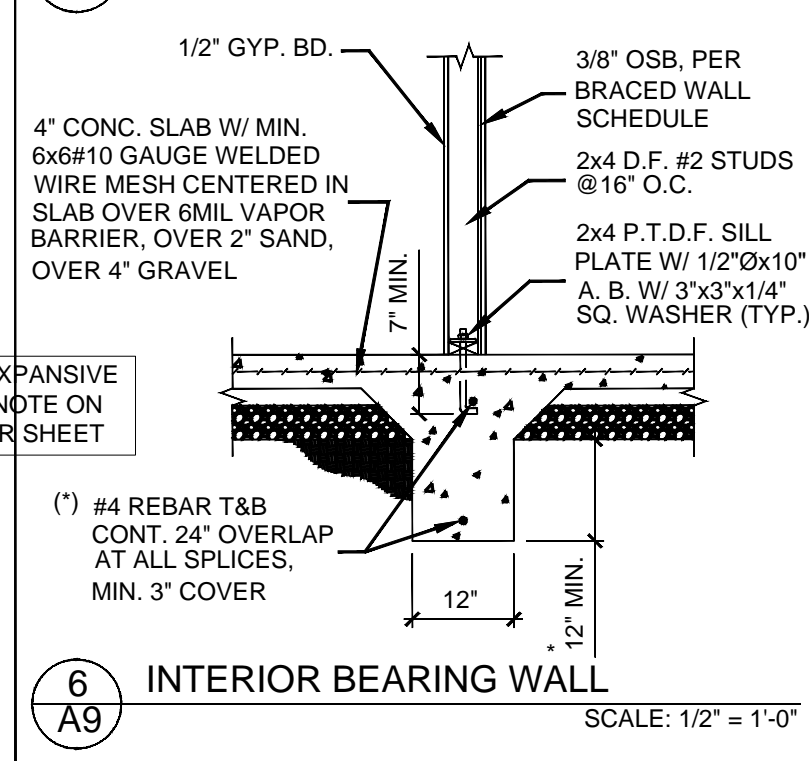


**6 A9** INTERIOR BEARING WALL  
SCALE: 1/2" = 1'-0"

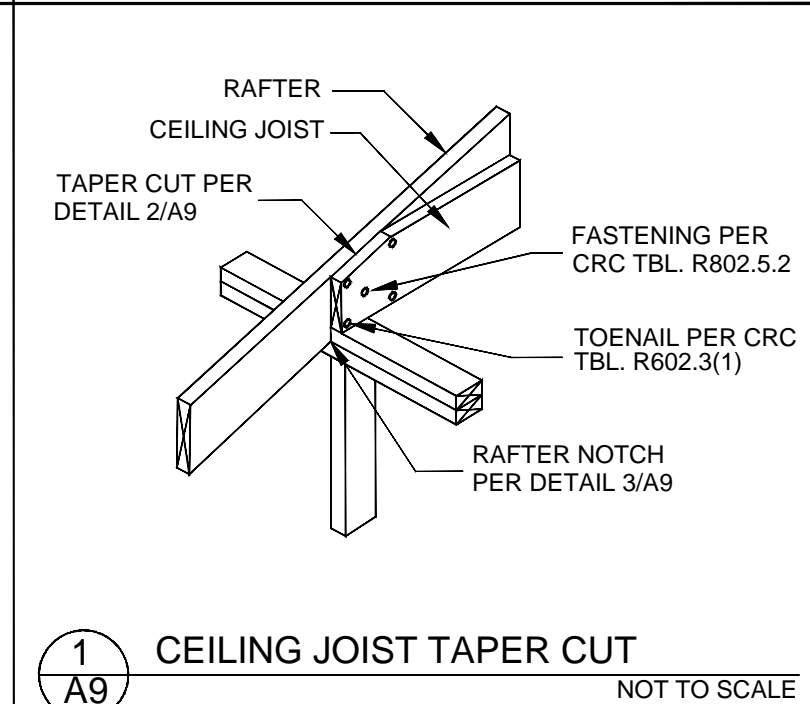

**1 A9** CEILING JOIST TAPER CUT  
NOT TO SCALE

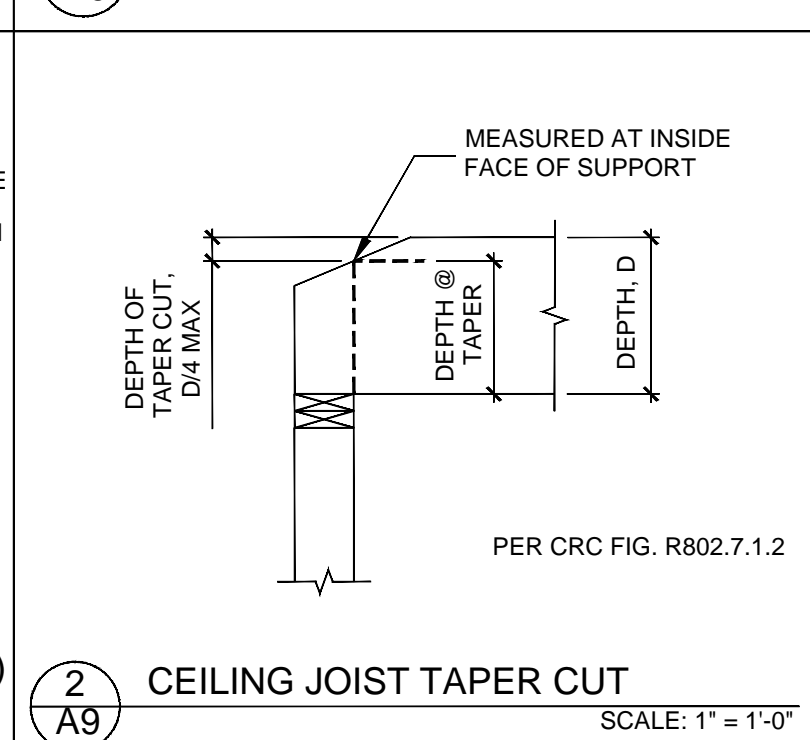

**2 A9** CEILING JOIST TAPER CUT  
SCALE: 1" = 1'-0"

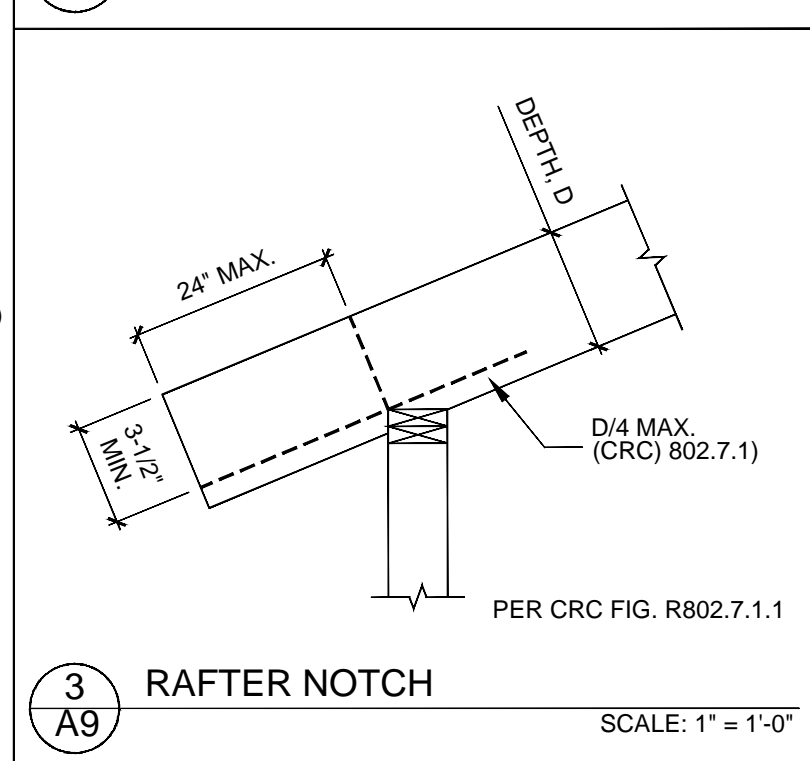

**3 A9** RAFTER NOTCH  
SCALE: 1" = 1'-0"

